COLLEGE OF THE REDWOODS COMMUNITY STADIUM UPGRADE



REDWOODS COMMUNITY COLLEGE DISTRICT 7351 TOMPKINS HILL RD, EUREKA CA 95501 DSA# 01-121308 FILE# 12-C1


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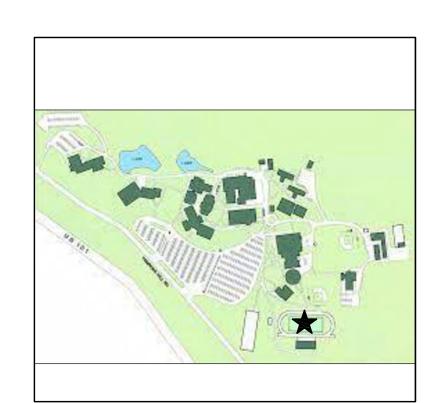


REGIONAL MAP

PROJECT SITE



AREA MAP

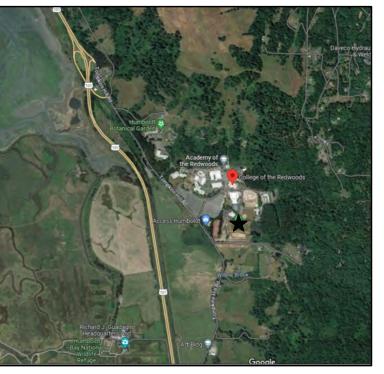


CAMPUS MAP

tBP / Architecture


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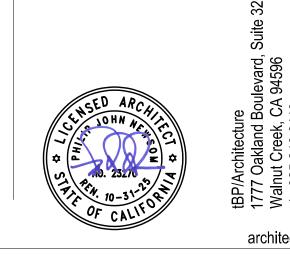
DSA CERTIFICATION OF THIS PROJECT #01-121308 IS CONTINGENT UPON THE CERTIFICATION OF PROJECT #01-119705

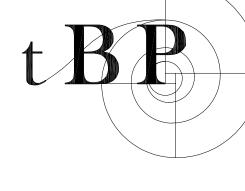

Architecture
Planning
Interiors

DSA #: 01-121308



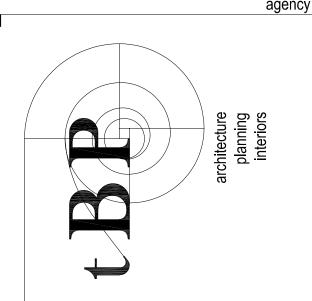

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REDWOODS

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tBP project number: 22079.00

file name: G000 Cover.dwg

drawn by: checked by:

date: 12/06/23

rev: date: description:

09/08/23 SCHEMATIC DWGS

10/09/23 DESIGN DEVELOPMENT

11/01/23 75% CONSTRUCTION DV

11/20/23 BID SET


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drawing title:


COVER SHEET

G000

ABBREVIATIONS	DRAWING LIST	
Mail Control Mail	GENERAL GUID COVER SHEET GUID SHEET INDEX PROJECT DIRECTORY FILE AND TRACK COLOR LAYOUT PLAN FILE AND TRACK COLOR MAN FILE AND TRACK SHOW COMMON PLAN F	DSA #: 01-121308 agency architecture Planning Interiors A 94596
March Marc	APPLICABLE CODES 1. 202 EDITION OF TITLE SHIPALAFORMA BUILDING STANDARDS CODE; OF THE CAUFORMA CODE OF REGULATIONS CODE, AND THE LATEST SUPPLIEDENTS. PARTICI CAUFORMA BUILDING STANDARDS SUIL DING STANDARDS CODE; OF THE CAUFORMA CODE OF CREC. PARTICIA CAUFORMA MULTICAL CODE (CRC). PARTICIA CAUFORMA MEMBRING CODE (CRC). PARTICIA CAUFORMA MEMBRING CODE (CRC). PARTICIA CAUFORMA PERENT CODE: OF CRC). PARTICIA CAUFORMA PERENT CAUFORMA PERENT CODE: OF CRC). PARTICIA CAUFORMA PERENT CAUFORMA PERENT CODE: OF CAUFORMA PERENT CODE: OF CAUFORMA PERENT CAUFORMA PERENT CODE: OF CAUFORS	COR COMMUNITY STADIUM UPGRADE COLLEGE OF THE REDWOODS REDWOODS COMMUNITY COLLEGE DISTRICT REDWOODS COMMUNITY COLLEGE DISTRICT REDWOODS COMMUNITY COLLEGE DISTRICT REDWOODS COMMUNITY COLLEGE DISTRICT 7351 TOMPKINS HILL RD, EUREKA, CA 95501 This 955-246 6419
	ALL WORK SHALL CONFORM TO 2022 EDMONTITLE 24, CALLFORNIA CODE OF REGULATIONS, CONSTRUCTION CHANGE DOLORANT CONTROL OF THE APPROVED DRAWINGS AND SPECIFICATIONS SHALL BE MADE BY ADDERNO AGR CONSTRUCTION CHANGE DOCUMENT (COL) APPROVED BY OSA AS REQUIRED BY SECTION ASS, PART I, TITLE 24, DESTRICT (OWNER) AND APPROVED FOR SHALL PROVED CONTROLS IS REFERENCED TO THE WORK THE DUTIES OF THE WORK THE CONTROL OF THE WORK THE CONTROL OF THE WORK THE CONTROL OF THE WORK CONSTRUCTION OF BEDSOARDENING AND SPECIFICATIONS IS THAT THE WORK OF THE CONTROL OF THE WORK CONSTRUCTION OF BEDSOARDENING BY THE CONTROL OF THE WORK SHOWN THE FIRST HE WORK WILL NOT COME? WITH THE 24, COR 34-00 BY THE PROJECT OF THE WORK SHOWN THERE DUTIES OF THE WORK SHOWN THE FEBRUAR OF THE WORK SHOWN THE WORK SHOWN T	rev: date: description: 09/08/23 SCHEMATIC DWGS 10/09/23 DESIGN DEVELOPMENT DWG 11/01/23 75% CONSTRUCTION DWGS 11/20/23 DSA SUBMITTAL 12/06/23 BID SET THIS DRAWING AND THE DESIGNS, DEPICTIONS, IDEAS AND OTHER INFORMATION CONTAINED HEREIN CONSTITUTE UNPUBLISHED WORK OF 18P/ARCHITECTURE AND SHALL REMAIN PROPERTY OF 18P/ARCHITECTURE IN PERPETURY. NO PART THEREOF SHALL BE REPRODUCED, DISCLOSED, DUBLISHED OR OTHERWISE USED IN ANY WAY WITHOUT THE ADVANCED EXPRESS WRITTEN CONSENT OF 18P/ARCHITECTURE. drawing title: SHEET INDEX / PROJECT DIRECTORY drawing no.: G001



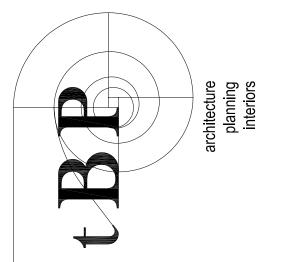

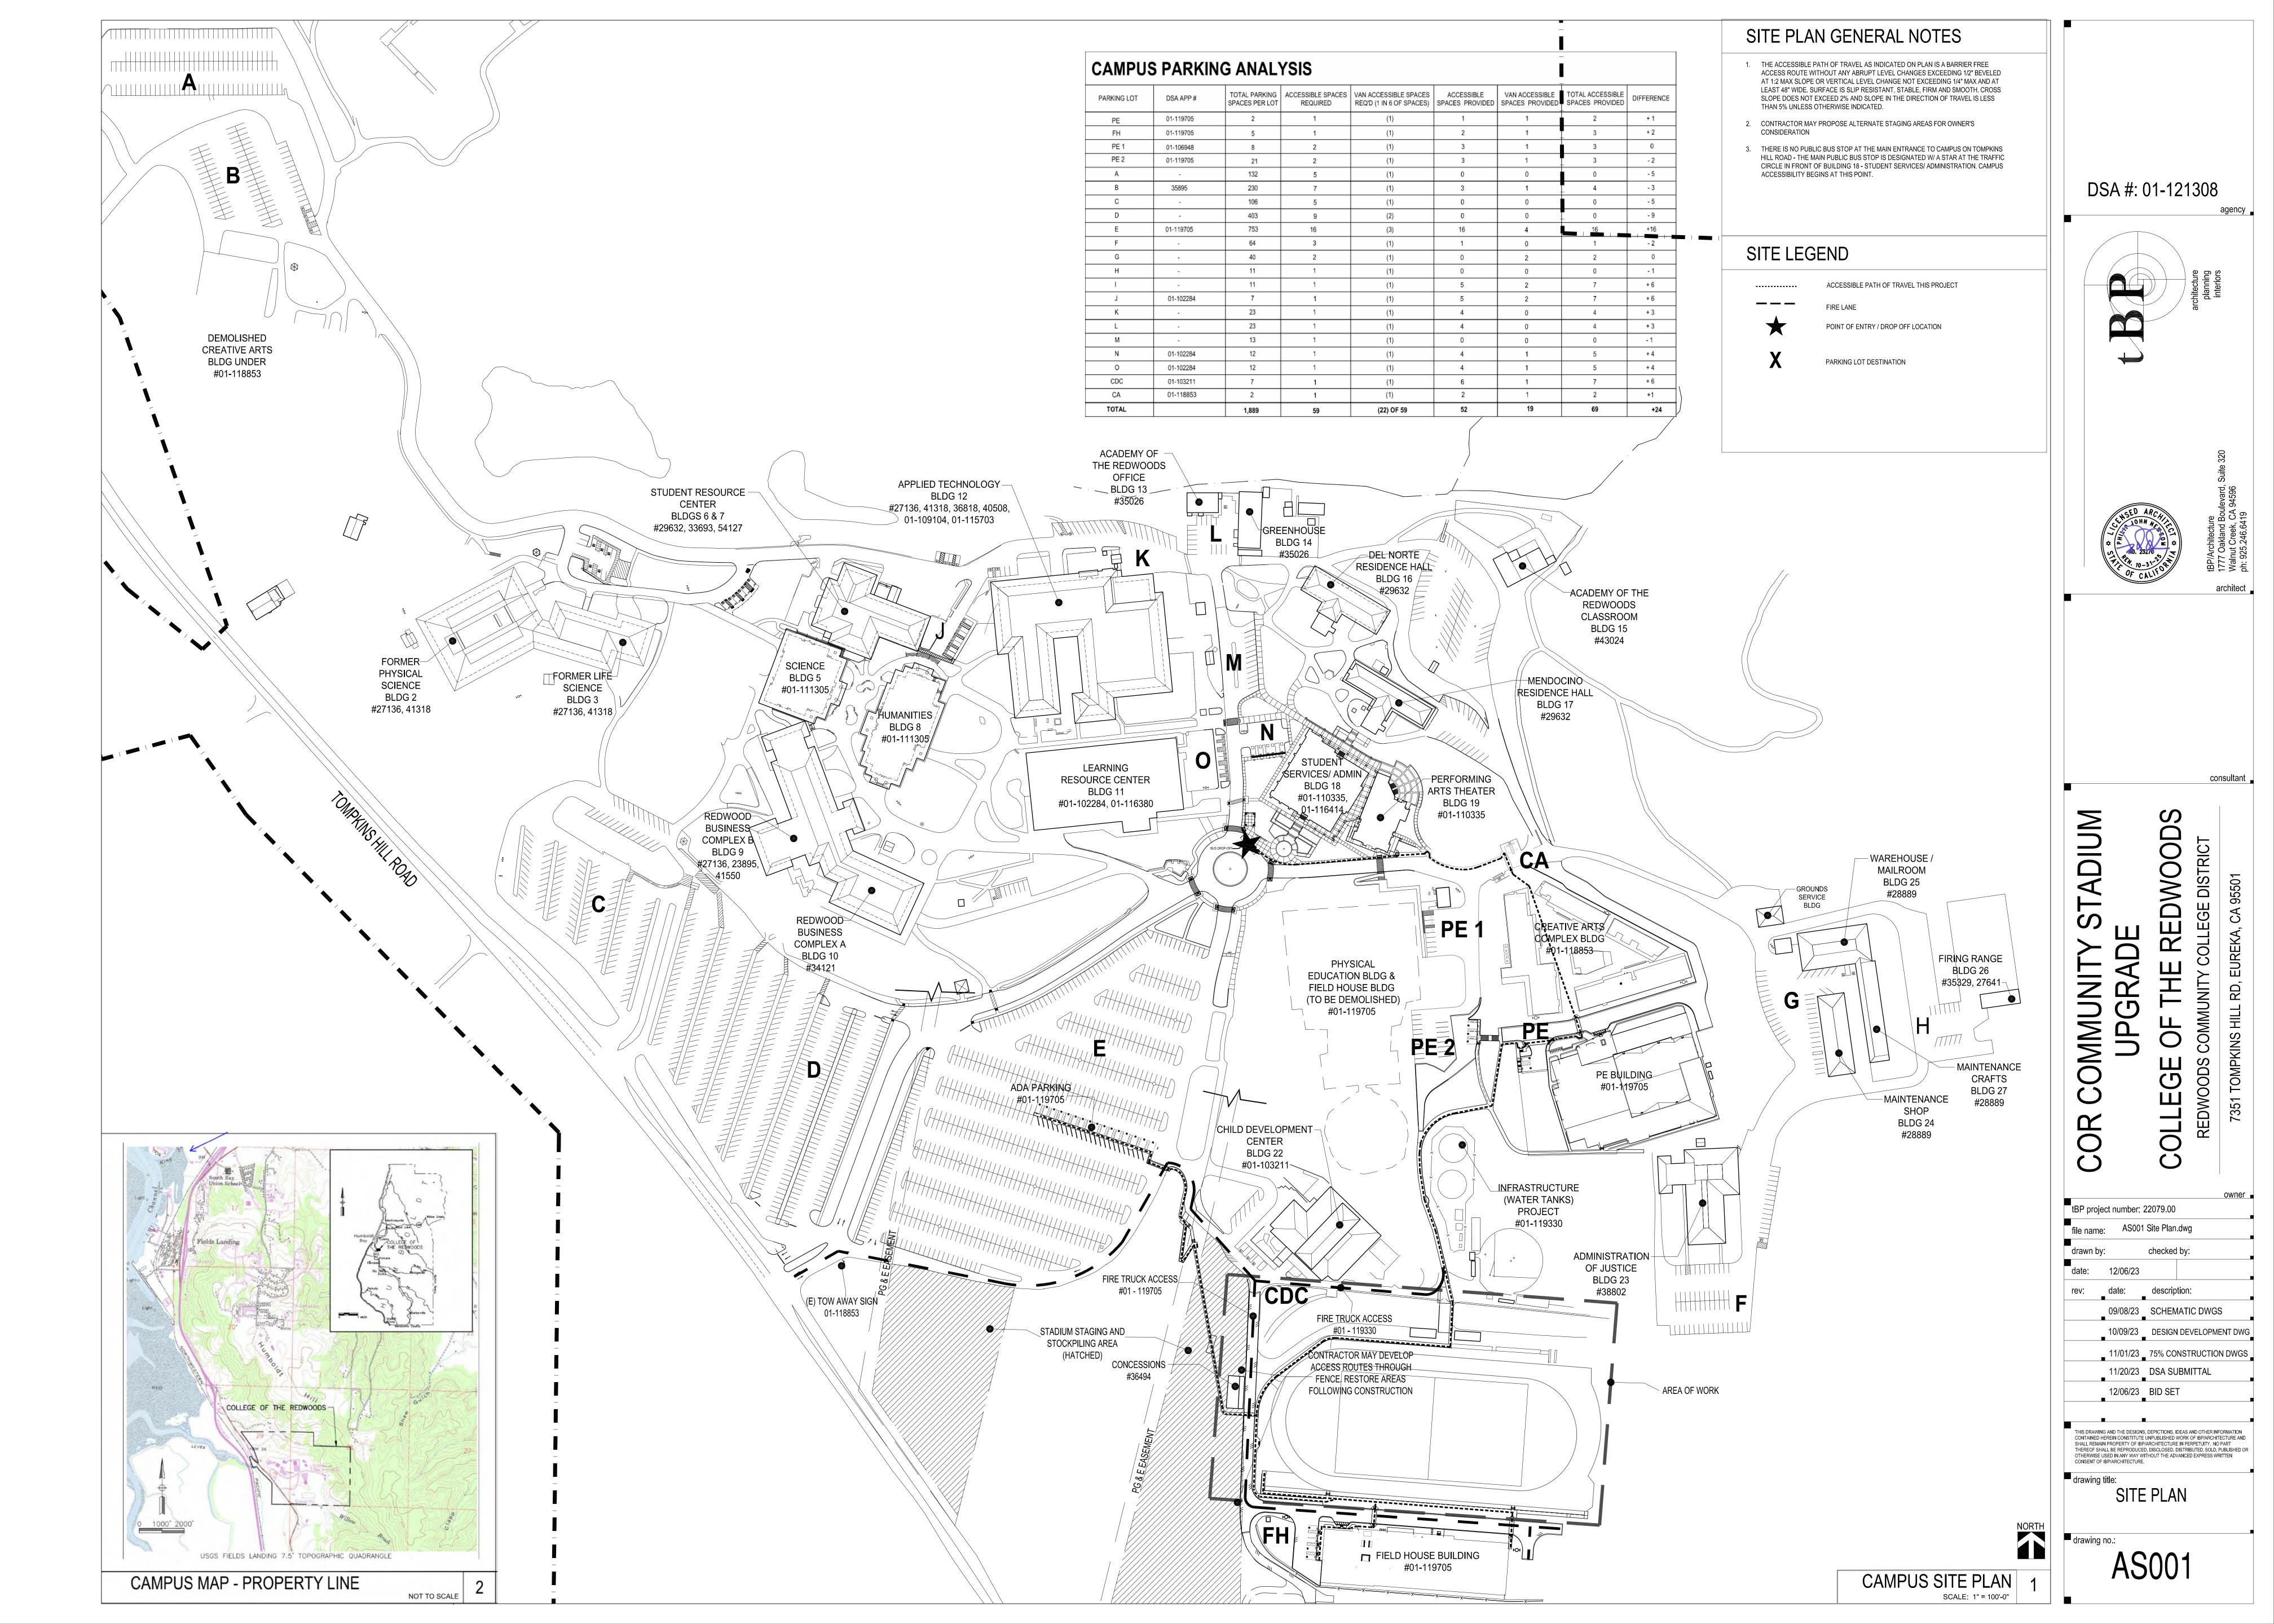

GENERAL SITE NOTES SURVEY NOTES COLLEGE OF THE REDWOODS GENERAL NOTES 1. CONTRACTOR SHALL FIELD VERIFY ALL EXISTING SITE CONDITIONS AND REVIEW ALL AVAILABLE REFERENCE DRAWINGS 1. ORIGINAL TOPOGRAPHIC SURVEY WAS PERFORMED BY LACO ASSOCIATES, DATED MARCH, 2018 AND POINTS WEST PRIOR TO THE COMMENCEMENT OF WORK AND REPORT ANY DISCREPANCIES TO THE OWNER'S REPRESENTATIVE. SURVEYING IN APRIL 2023, AND OCTOBER, 2023. CONTRACTOR IS RESPONSIBLE FOR VISITING THE SITE AND BECOMING FAMILIAR WITH THE SITE CONDITIONS PRIOR TO HORIZONTAL CONTROL IS CCS83 (2011) CALIFORNIA STATE PLANE ZONE 1, 2010 EPOCH.. VERTICAL CONTROL IS NORTH 2. IT IS THE CONTRACTOR'S RESPONSIBILITY TO VERIFY THE LOCATION OF ALL EXISTING UTILITIES WITH THE IT IS EXPECTED THAT THE ACTUAL LOCATION OF EXISTING UTILITIES MAY VARY FROM THAT SHOWN ON THE PLANS. CONTRACTOR SHALL POTHOLE AND LOCATE ALL EXISTING UTILITIES. CONTRACTOR SHALL NOTIFY UNDERGROUND 3. SEE SHEET CD-101 FOR SURVEY CONTROL POINTS. SERVICE ALERT PRIOR TO WORK COMMENCING FOR ANY EXCAVATION OR POTHOLING. 4. TEMPORARY FACILITIES ARE BASED ON ESTIMATES GIVEN AT THE TIME OF DESIGN AND MAY VARY FROM FIELD CONTRACTOR IS RESPONSIBLE FOR CONFIRMING THAT NEW FEATURES TIE INTO EXISTING SITE DEVELOPMENT PAVEMENT JOINTS MATCH CORRECTLY, AND THAT GENERAL DESIGN ELEVATIONS FOR NEW CONSTRUCTION PROVIDE PROPER PAVEMENT AND DRAINAGE SLOPES FROM EXISTING TIE IN POINTS. REPORT DISCREPANCIES TO OWNER'S THE PURPOSE OF THIS SURVEY IS DETERMINE TOPOGRAPHY ON THE EXISTING FOOTBALL FIELD AND TRACK AT THE REPRESENTATIVE PRIOR TO CONSTRUCTION. COLLEGE OF THE REDWOODS EUREKA CAMPUS. FIELD SURVEYS WERE PERFORMED IN APRIL AND OCTOBER 2023. 4. UPON COMPLETION OF THE CONSTRUCTION PROJECT, THE CONTRACTOR SHALL LEAVE THE PROJECT AREA FREE OF HORIZONTAL AND VERTICAL CONTROL FOR THIS PROJECT IS BASED ON CONTROL ESTABLISHED BY LACO ASSOCIATES DEBRIS AND UNUSED MATERIAL. ALL DAMAGE CAUSED BY THE CONTRACTOR SHALL BE RESTORED TO AN "AS GOOD OR IN MARCH 2018 PER DATA PROVIDED TO POINTS WEST SURVEYING (PWS). THIS CONTROL WAS PROVIDED FOR USE BY PWS IN AUGUST 2020 AS PART OF A TOPOGRAPHIC SURVEY VERIFICATION PROJECT FOR GHD. HORIZONTAL DATUM IS CCS83, STATE PLANE, ZONE 1, 2010 EPOCH. COMBINED SCALE FACTOR PROVIDED PER THE LACO SURVEY IS 5. CONTRACTOR TO MAINTAIN TRAFFIC (VEHICULAR AND PEDESTRIAN) ACCESS TO ALL AREAS OF CAMPUS AT ALL TIMES. 0.99990172. THE FILE CONTAINS GRID DISTANCES. ELEVATIONS SHOWN HEREON ARE NAVD88 ELEVATIONS BASED ON CONTRACTOR TO COORDINATE ANY PROPOSED SHUT DOWNS WITH OWNER. THE SAME LACO CONTROL SURVEY. 6. EXISTING ACCESSIBLE ROUTES AND ACCESSIBLE PARKING SERVING FACILITIES AND BUILDINGS THAT ARE OPERATIONAL TRACK STRIPING IS APPROXIMATE AND WAS NOT LOCATED BY SURVEY. STRIPING SHOWN HEREON IS BASED ON 3.5' DURING CONSTRUCTION SHALL REMAIN UNOBSTRUCTED, SAFE AND USABLE BY PEOPLE WITH DISABILITIES. LANE WIDTH MEASURED IN FIELD. TRACK HAS 8 LANES AS SHOWN HEREON. 8. FLAGS SHOWN WITHIN THE FOOTBALL FIELD ARE LOCATION OF EXISTING SPRINKLERS PER CONVERSATION WITH SEAN PATTON, HEAD GARDENER. ROUTING OF SPRINKLER SYSTEM PIPING IS UNKNOWN. **GRADING NOTES** EXISTING FOOTBALL FIELD DOES NOT HAVE ANY UNDERDRAIN OR SUBDRAIN SYSTEM PER SEAN PATTON. DRAINAGE IS BASED ON CROWNED FIELD SHAPE AS SHOWN BY CONTOURS HEREON WHICH THEN DRAINS INTO CONCRETE TRENCH SURVEY OF EXISTING CONDITIONS PREPARED BY MULTIPLE ENTITIES. SEE SURVEY NOTES. THE CONTRACTOR IS RESPONSIBLE FOR FIELD VERIFICATION OF ALL SURVEY DATA. CONTRACTOR IS RESPONSIBLE FOR VERIFYING AND UTILITY ROUTING SHOWN HEREON IS BASED ON A COMBINATION OF VISIBLE APPURTENANCES LOCATED IN THE FIELD, ESTABLISHING ALL HORIZONTAL AND VERTICAL CONTROL PRIOR TO CONSTRUCTION. UTILITY MAPPING AND PLANS FOUND DURING RESEARCH AT THE CAMPUS PLAN ROOM, AND A SITE WALKTHROUGH WITH SEAN PATTON, HEAD GARDENER. ROUTING SHOWN HEREON IS THE BEST INTERPRETATION BY PWS AND 2. CONTRACTOR IS RESPONSIBLE FOR CONSTRUCTION STAKING AND SHALL ARRANGE FOR STAKING BY A LICENSED SHOULD BE VERIFIED PRIOR TO GROUND DISTURBANCE OR CONSTRUCTION. SEE UNDERGROUND UTILITY NOTE SURVEYOR. STAKING WILL BE REVIEWED BY OWNER'S REPRESENTATIVE FOR CONFIRMATION TO DESIGN PRIOR TO 11. STORM DRAIN ROUTING IS BASED ON FIELD INVESTIGATION. RESEARCH AT CAMPUS PLAN ROOM FOUND A STORM 3. ALL GRADES BETWEEN SPOT ELEVATIONS SHALL HAVE UNIFORM SLOPE UNLESS OTHERWISE INDICATED. MAINTAIN DRAINAGE MASTER PLAN BY LACO ASSOCIATES. THIS SURVEY FOUND DIFFERENCES WITH INFORMATION SHOWN ON POSITIVE DRAINAGE AWAY FROM ALL BUILDING WALLS AND DOORS. THAT PLAN, SPECIFICALLY THE ROUTING OF THE POND OVERFLOW INTO THE STORM DRAINAGE SYSTEM AND THE ROUTING OF THE STORM DRAIN SHOWN UNDER THE CHILD DEVELOPMENT CENTER. NO INFORMATION COULD BE 4. CONTRACTOR SHALL BE RESPONSIBLE FOR THE SAFETY OF ALL CONSTRUCTION. ADEQUATE SHORING BRACING, TIES, FOUND FOR THE STORM DRAINAGE SYSTEM ALONG THE NORTH SIDE OF THE CONCRETE/ROCK WALL ON THE SOUTH AND SUPPORTS SHALL BE USED TO PROVIDE PROPER TEMPORARY INTEGRITY DURING ALL PHASES OF CONSTRUCTION. SIDE OF THE PROJECT SITE. ALL EXISTING LANDSCAPED AND UNPAVED AREAS WHICH ARE DISTURBED BY CONSTRUCTION OR EARTHWORK 12. ELECTRIC ROUTING IS APPROXIMATE AND IS BASED ON SEVERAL SCHEMATIC PLANS FOUND IN CAMPUS PLAN ROOM. OPERATIONS SHALL BE HAND RAKED SMOOTH, ROCKS REMOVED, AND HYDROSEEDED.. SURVEYOR BELIEVES THAT DUAL BOXES ALONG NORTH SIDE OF TRACK ARE PROBABLY ELECTRIC AND COMMUNICATION IN PARALLEL TRENCHES. THESE SYSTEMS SHOULD BE INVESTIGATED PRIOR TO ANY WORK. 6. ALL DITCHES, SWALES, GUTTERS, ETC. SHOULD BE CONSIDERED ACTIVE STORM CONVEYANCES UNLESS OTHERWISE INDICATED. CONTRACTOR IS RESPONSIBLE FOR ADDRESSING STORM WATER DRAINAGE AND DEWATERING OF WORK TREES SHOWN HEREON WERE LOCATED AT AND DIAMETERS GIVEN AT APPROXIMATE BREAST HEIGHT. ONLY AREAS DURING CONSTRUCTION. CONIFEROUS TREES WERE LOCATED ALONG THE POND EDGE ON THE EASTERN PORTION OF THE SITE. THE DECIDUOUS TREES IN THIS AREA, ESPECIALLY THE ALDERS, GROW IN MULTIPLE DIRECTIONS HORIZONTAL AND 7. DURING WET WEATHER PERIODS, CONTRACTOR IS RESPONSIBLE FOR SEQUENCING CONSTRUCTION IN A MANNER TO VERTICAL. THIS SURVEY DOES NOT SHOW THESE TREES. DECIDUOUS TREES WERE LOCATED ALONG THE DRAINAGE MINIMIZE IMPACT ON OPEN EARTHWORK AND COMPACTION OPERATIONS. CHANNEL SHOWN ON SHEET 2 (TO THE NORTH). 8. COMPLETELY COVER ANY SOIL STOCKPILES WITH 6 MIL BLACK PLASTIC AND PROVIDE RESTRAINTS TO HOLD PLASTIC IN PLACE. MONITOR PLASTIC COVER AS PART OF CONTINUOUS EROSION CONTROL PLAN. PLACE SILT FENCE COMPLETELY **UTILITY NOTES** AROUND STOCKPILES. 1. LOCATIONS OF EXISTING UNDERGROUND UTILITIES ARE PLOTTED FROM RECORD DRAWINGS AND INTERPOLATION OF **EROSION CONTROL NOTES** PHYSICAL EVIDENCE ON THE SITE AND ARE SUBJECT TO FIELD VERIFICATION BY THE CONTRACTOR. SEE GENERAL SITE NOTES 1 AND 2. SEE UTILITY LOCATING AND MAPPING SPECIFICATIONS. 2. ALL LOCATIONS FOR WORK SHALL BE CHECKED AND COORDINATED WITH EXISTING CONDITIONS IN THE FIELD BEFORE 1. CONTRACTOR SHALL BE RESPONSIBLE FOR PREPARING AND IMPLEMENTING THE PROJECT SWPPP PER THE BEGINNING CONSTRUCTION UNDER THIS SECTION OR ANY OTHER SECTION. **CURRENT NPDES GENERAL PERMIT REQUIREMENTS** 3. THE WORKING DRAWINGS ARE GENERALLY DIAGRAMMATIC. THEY DO NOT SHOW EVERY OFFSET, BEND OR ELBOW 2. CONTRACTOR SHALL BE RESPONSIBLE FOR ALL MONITORING AND REPORTING. THE OWNER SHALL REQUIRED FOR INSTALLATION IN THE SPACE PROVIDED. THEY DO NOT SHOW EVERY DIMENSION, COMPONENT PIECE, REGISTER THE PROJECT VIA SMARTS AND ESTABLISH ACCESS FOR THE QUALIFIED STORMWATER OR FITTING REQUIRED TO COMPLETE THE PROJECT. CONTRACTOR IS RESPONSIBLE FOR PROVIDING A COMPLETE AND PRACTITIONER (QSP) PROVIDED BY THE CONTRACTOR. THE EROSION CONTROL MEASURES SHOWN HERE ARE THE MINIMUM RECOMMENDED. THE CONTRACTOR CONTRACTOR SHALL COORDINATE WITH USA NORTH (811) 72 HOURS MINIMUM PRIOR TO BEGINNING ANY UTILITY SHALL ADHERE TO THE QSD\QSP SPECIFIC PLAN OF BMP'S (BEST MANAGEMENT PRACTICES) FOR THE CONSTRUCTION. CONTRACTOR SHALL COORDINATE THE UTILITY LOCATE WITH THE OWNER FOR ALL UTILITY WORK. PROJECT SITE APPROPRIATE TO THE PHASE OF CONSTRUCTION AND THE TIME OF YEAR. CONTRACTOR TO NOTE THAT CAMPUS OWNED UTILITIES WILL NOT BE MARKED VIA A USA LOCATE. CONTRACTOR TO EMPLOY THEIR OWN UTILITY LOCATING TECHNIQUES ALONG ALL PROPOSED ROUTES OF NEW UTILITIES AND TO MARK 4. BACK UP EROSION CONTROL MATERIALS SHALL BE STOCKPILED ON THE SITE TO ALLOW FOR TIMELY ALL CAMPUS OWNED UTILITIES AFFECTED BY CONTRACTORS WORK. CONTRACTOR SHALL SETUP PRE-CONSTRUCTION REPAIR AND MAINTENANCE OF ALL BMP'S. MEETING WITH USA NORTH WHEN CONSTRUCTING WITHIN 10' OF A HIGH PRIORITY UTILITY PER USA NORTH REQUIREMENTS INFORM OWNER IMMEDIATELY IF LOCATE INDICATES THAT EXISTING UTILITIES ARE DIFFERENT THAN SHOWN ON DRAWINGS. VEGETATION PROTECTION AND RESTORATION NOTES CONTRACTOR IS RESPONSIBLE FOR POTHOLING ALONG THE ALIGNMENTS OF ALL NEW UTILITIES TO IDENTIFY POTENTIAL UTILITY CONFLICTS, SOILS CONDITIONS, AND TIE-IN POINTS. CONTRACTOR RESPONSIBLE FOR MAKING ADJUSTMENTS IN ALIGNMENTS TO ACCOMMODATE ACTUAL FIELD CONDITIONS. 1. NO CUTTING OF ANY PART OF TREES, INCLUDING ROOTS, SHALL BE DONE WITHOUT SECURING APPROVAL FROM 6. CONTRACTOR IS RESPONSIBLE FOR ANY DAMAGE TO UTILITIES, FEATURES, AND STRUCTURES LOCATED ON THE SITE. LOCATE, PROTECT, AND AVOID DISRUPTION OF ALL ABOVE AND BELOW GRADE UTILITIES DURING CONSTRUCTION. WHEN CONSTRUCTION OCCURS WITHIN DRIP LINE ON EXISTING TREES, CONTRACTOR IS TO PILE THE SOIL ON THE SIDE AWAY FROM THE TREE. WHEN THIS IS NOT POSSIBLE, PLACE SOIL ON PLYWOOD. A TARP, OR THICK BED OF MULCH. THIS IS TO HELP PREVENT CUTTING INTO THE SOIL SURFACE WHEN THE BACKHOE OR TRACTOR BLADE REFILLS THE 7. ALL UTILITY CONSTRUCTION OUTSIDE OF THE RIGHT-OF-WAYS SHALL CONFORM TO THE LATEST EDITION OF THE CALIFORNIA PLUMBING CODE (CPC). ALL UTILITY CONSTRUCTION WITHIN THE RIGHT-OF-WAY SHALL CONFORM TO THE COLLEGE OF THE REDWOODS STANDARDS. 3. REFILL OPEN TRENCHES QUICKLY WITHIN 4 HOURS OF EXCAVATION WHEN THEY OCCUR WITHIN THE DRIP LINE OF 8. ALL BURIED LINES TO HAVE 36 INCHES MINIMUM COVER, UNLESS NOTED OTHERWISE. EXISTING TREES. IF THIS IS NOT POSSIBLE AND WEATHER IS HOT, DRY, OR WINDY, CONTRACTOR MUST KEEP ROOT ENDS MOIST BY COVERING THEM WITH WET BURLAP. IF TEMPERATURE IS 80°F OR GREATER, THE BURLAP MUST BE INSPECTED EVERY HOUR AND RE-WET A NECESSARY TO MAINTAIN A CONSTANT COOL MOIST CONDITION. IF 9. APPROXIMATE BUILDING UTILITY CONNECTIONS ARE SHOWN ON SITE DRAWINGS WHERE FOUND. COMPLETENESS OF TEMPERATURE IS BELOW 80°, THE BURLAP MUST BE INSPECTED EVERY FOUR HOURS AND RE-WET AS NECESSARY TO BUILDING CONNECTIVITY IS NOT GUARANTEED. CONTRACTOR SHALL LOCATE UTILITY CONNECTIONS TO BUILDINGS. MAINTAIN A CONSTANT COOL MOIST CONDITION. SMALL ROOTS CAN DRY OUT AND DIE IN 10-15 MINUTES. LARGER CONTRACTOR SHALL FURNISH AND INSTALL ALL PIPING, FITTINGS, AND APPURTENANCES REQUIRED TO ENSURE THAT ROOTS CAN SUCCUMB IN AN HOUR OR LESS UNDER UNFAVORABLE WEATHER CONDITIONS. BUILDING CONNECTIVITY REMAINS INTACT. REFER TO BUILDING DRAWINGS FOR CONTINUATION OF UTILITY LINES INTO WHEN ROOTS 2" OR LARGER MUST BE CUT, SHOVEL BY HAND NEAR THE ROOTS AND SAW THE ROOTS. ACCIDENTALLY BROKEN ROOTS SHOULD BE SAWED A COUPLE OF INCHES BEHIND THE RAGGED END. CRUSHED OR TORN ROOTS ARE 10. CONTRACTOR TO VERIFY CONNECTIVITY OF UTILITY NETWORK PRIOR TO REPLACEMENT, ABANDONMENT, OR MORE LIKELY TO ALLOW DECAY TO BEGIN; SHARPLY CUT ROOTS PRODUCE A FLUSH OF NEW ROOTS HELPING THE TREE DEMOLITION OF EXISTING UTILITY. CONTRACTOR TO CONFIRM CONNECTIVITY OF NEW UTILITY PRIOR TO COMPLETING MATERIALS, EQUIPMENT, TEMPORARY BUILDINGS, FUELS, PAINTS AND OTHER CONSTRUCTION ITEMS ARE NOT TO BE 11. THRUST BLOCKING REQUIRED ON ALL PRESSURE LINES BENDS AND FITTINGS. SEE STANDARD THRUST BLOCKING PLACED WITHIN THE DRIP LINE OF EXISTING TREES. DETAIL. RESTRAINED FITTINGS MAY BE USED AS AN ALTERNATIVE WHEN INSTALLED ON FITTINGS AND LINES PER

MANUFACTURER REQUIREMENTS TO ACHIEVE PROPER RESTRAINT OF THE OVERALL PIPING SYSTEM WITH THE

12. ALL EXISTING UTILITIES AND TIE-IN POINTS SHOULD BE CONSIDERED ACTIVE UTILITIES UNLESS OTHERWISE INDICATED.

13. CONFIRM FIRE HYDRANT TYPE, NOZZLE SIZES, AND THREAD CONFIGURATIONS SHALL MATCH OTHER HYDRANTS ON

13. CONFIRM ALL UTILITY VALVE VAULTS, VALVES, METERS, BACKFLOW PREVENTION ASSEMBLIES, AND OTHER UTILITY

14. CONTRACTOR MAY PROPOSE HORIZONTAL DIRECTIONAL DRILLING ALIGNMENT ALTERNATIVES. CONTRACTOR SHALL

LIMITED TO HAND TOOLS AND MUST BE COORDINATED WITH PG & E PRIOR TO ANY EXCAVATION. ANY ADJUSTMENT AND / OR CORRECTION TO ANY UTILITY WORK SHOWN ON THESE PLANS THAT AFFECTS A PG & E UTILITY MUST BE

SHOWN ON THE PLANS TO BE REMOVED. CONTRACTOR TO TEST UTILITIES AND VERIFY CONNECTIVITY AND INSTALL

LINE CAPS AND INTERCONNECTIONS AS NECESSARY TO MAINTAIN UTILITY CONNECTIVITY TO REMAINING AREAS OF

1. NOT ALL EXISTING IRRIGATION LINES AND ELECTRICAL AND CONTROLS FOR IRRIGATION SYSTEMS ARE SHOWN ON THE PLANS.

CONTRACTOR IS RESPONSIBLE FOR LOCATING, REROUTING, REPLACING, AND REPAIRING ANY IRRIGATION LINES DAMAGED

3. CONTRACTOR SHALL COORDINATE WITH OWNER TO RELOCATE IRRIGATION LINES FOUND TO BE IN CONFLICT WITH NEW

4. CONTRACTOR IS RESPONSIBLE FOR RECONNECTING THE EXISTING IRRIGATION SYSTEM TO NEW WATER DISTRIBUTION

SYSTEM, UNLESS NOTED OTHERWISE, CONTRACTOR SHALL FURNISH AND INSTALL ALL PIPING, FITTINGS, AND

5. EXISTING IRRIGATION SYSTEMS ARE GENERALLY NOT SHOWN. CONTRACTOR SHALL ASSUME ALL EXISTING TURF AND

RECONNECT IRRIGATION SYSTEMS TO REMAIN. CONTRACTOR TO COORDINATE WITH CAMPUS STAFF.

LANDSCAPED AREAS HAVE IRRIGATION SYSTEMS WHICH SHALL BE REPAIRED OR MODIFIED AS REQUIRED AT CONTRACTOR'S

THE LOCATION OF THE IRRIGATION SYSTEMS IN THE VICINITY OF THE WORK ARE UNKNOWN. CONTRACTOR TO REPAIR AND

UTILITY CONSTRUCTION. THE COST OF IDENTIFYING, LOCATING, RELOCATING, REROUTING, REPAIRING, OR REPLACING

IRRIGATION EQUIPMENT IS CONSIDERED INCIDENTAL TO THE OVERALL PROJECT AND THE COST SHALL BE INCLUDED IN

15. PACIFIC GAS AND ELECTRIC UTILITY LOCATIONS ARE APPROXIMATE. ANY PG & E UTILITY VERIFICATION IS TO BE

16. CONTRACTOR MAINTAIN OVERALL CAMPUS UTILITY CONNECTIVITY AFTER DEMOLITION OF BUILDS AND UTILITIES

EXCEPTION OF FIRE HYDRANTS WHICH MUST HAVE THRUST BLOCKS PER THE DETAIL.

APPURTENANCES WITH THE OWNER.

IRRIGATION SYSTEM NOTES

COORDINATE WITH OWNER FOR ALL DESIGN ALTERNATIVES.

COORDINATED WITH PG & E. SEE GENERAL SITE NOTES 1 & 2.

CONTRACTOR'S BID FOR THE WORK THAT AFFECTS IRRIGATION.

EXPENSE TO ACCOMMODATE OTHER REQUIRED IMPROVEMENTS.

APPURTENANCES REQUIRED TO RECONNECT EXISTING IRRIGATION SYSTEM.

- 6. GRADING SHOULD NOT CREATE DRAINAGE PROBLEMS FOR TREES BY CHANNELING WATER INTO THEM, OR CREATING
- 7. LANDSCAPING THAT IS REMOVED TO FACILITATE CONSTRUCTION SHALL BE REPLACED IN KIND.
- 8. ALL DISTURBED AREAS THAT ARE NOT OTHERWISE COVERED OR LANDSCAPED SHALL BE HYDROSEEDED PER THE SPECIFICATIONS.
- 9. ALL DISTURBED SITES SHALL BE RAKED SMOOTH AND ALL SURFACE DEBRIS AND ROCKS GREATER THAN 3" SHALL BE REMOVED PRIOR TO HYDROSEEDING.

ADA NOTES

- 1. ALL SITE WORK SHALL BE IN CONFORMANCE WITH TITLE 24 OF THE CALIFORNIA ADMINISTRATIVE CODE AND WITH THE AMERICANS WITH DISABILITIES ACT.
- 2. CURB RAMPS SHALL NOT EXCEED A SLOPE OF 1:12 (8.33%).
- 3. RAMPS TO BUILDINGS SHALL NOT EXCEED A SLOPE OF 1:20 (5%) UNLESS RAILINGS ARE SHOWN ON ARCHITECTURAL PLANS, IN WHICH CASE THE SLOPE SHALL NOT EXCEED 1:12 (8.33%).
- 4. A 2% MAXIMUM SLOPE LANDING SHALL BE PROVIDED AT PRIMARY ENTRANCES TO BUILDINGS, THE LANDINGS SHALL HAVE A MINIMUM WIDTH OF 60" AND A MINIMUM DEPTH OF 60" WHEN THE DOOR OPENS INTO THE BUILDING, AND 42" PLUS THE WIDTH OF THE DOOR WHEN THE DOOR OPENS ONTO THE LANDING. LANDINGS SHALL HAVE A MINIMUM OF 24" STRIKESIDE CLEARANCE.
- RAMPS ARE DEFINED AS ANY WALKWAY BETWEEN SLOPES OF 1:20 (5%) AND 1:12 (8.33%), AND SHALL HAVE A MINIMUM WIDTH OF 48" AND A MAXIMUM CROSS-SLOPE OF 2%. RAMPS EXCEEDING 2'-6" VERTICAL SHALL HAVE INTERMEDIATE (2% MAXIMUM SLOPE) LANDINGS HAVING A MINIMUM LENGTH IN THE DIRECTION OF TRAVEL OF 60". BOTTOM LANDINGS AT CHANGES IN RAMP DIRECTION SHALL HAVE A MINIMUM LENGTH OF 72". RAMPS FINISH SHALL BE STABLE, FIRM, SLIP-RESISTANT, CONTAIN A 12 INCH WIDE CONTINUOUS GROOVED BORDER ALONG THE TOP EDGE, AND HAVE A DETECTABLE WARNING SURFACE AT THE BASE OF THE RAMP.
- MAXIMUM CROSS SLOPE ON ANY SIDEWALK OR RAMP SHALL BE 2%. MAXIMUM SLOPE WITHIN PARKING STALLS DESIGNATED AS ACCESSIBLE PARKING SHALL BE 2% IN ANY DIRECTION.
- 7. ALL SIDEWALKS SHALL HAVE A 4' MINIMUM CLEAR WIDTH FOR ACCESSIBLE CONFORMANCE.
- 8. DETECTABLE WARNING SURFACES SHALL BE INSTALLED ALONG WALKWAYS AND AT RAMPS PER ADA STANDARDS.
- 9. PROVIDE 80" OVERHEAD CLEARANCE AT WALKWAYS.
- 10. RAMP FINISH SHALL BE STABLE, FIRM, AND SLIP-RESISTANT PER ADA STANDARDS.

- ALL MATERIALS AND WORKMANSHIP SHALL CONFORM TO THE PROJECTS STANDARD DETAILS, TECHNICAL SPECIFICATIONS, AND GENERAL REQUIREMENTS.
- APPROPRIATE UTILITY AGENCIES PRIOR TO THE COMMENCEMENT OF CONSTRUCTION. CONTACTOR SHALL NOTIFY ALL PUBLIC AND PRIVATE UTILITY OWNERS 48 HOURS PRIOR TO COMMENCEMENT OF WORK ADJACENT TO THE UTILITY. CONTACT UNDERGROUND SERVICE ALERT (USA) AT 800-227-2600.
- ALL SIDEWALK, CURB, AND GUTTER SHALL BE REMOVED AND REPLACED TO THE NEAREST SCORE MARK OR AS DIRECTED BY THE OWNER'S REPRESENTATIVE. INSTALLATION OF NEW SIDEWALK, CURB, AND GUTTER AGAINST EXISTING IMPROVEMENTS SHALL REQUIRE A SIDEWALK CONTACT JOINT (DOWELS REQUIRED).
- UNLESS OTHERWISE DIRECTED BY THE OWNER'S REPRESENTATIVE IN THE FIELD: AT EACH LOCATION WHERE NEW CURB/GUTTER IS TO BE PROVIDED ON AN EXISTING STREET (DRIVEWAY INSTALLATION, DRIVEWAY ABANDONMENT, CURB RAMP INSTALLATION, CURB FACE DRAINAGE INSTALLATION, ETC.) PAVEMENT RECONSTRUCTION SHALL BE REQUIRED. AN 18-INCH WIDE BAND OF PAVEMENT SHALL BE REMOVED AND REPLACED ALONG THE ENTIRE LENGTH OF CURB/GUTTER INSTALLATION. REMOVAL (SAW CUTS REQUIRED) SHALL BE TO THE BASE MATERIAL ON STREET WITH A.C. OR P.C.C. PAVEMENT FOUR (4) INCHES OR LESS IN THICKNESS. REMOVAL DEPTH SHALL BE TWO INCHES MINIMUM ON STREETS WITH A.C. (GRIND) / P.C.C. (SAW CUT) PAVEMENT THICKNESS GREATER THAN FOUR (4) INCHES. REPLACE WITH A.C. PAVEMENT.
- BLACK SAND SLURRY SEAL SHALL BE REQUIRED ON ALL NEW STREET PAVEMENT FOR TRENCH WORK, POTHOLES. AND STREET WIDENING. SLURRY SEAL SHALL EXTEND TWELVE INCHES BEYOND THE LIMIT OF PAVEMENT
- THE CONTRACTOR SHALL NOTIFY THE OWNER IN WRITING AT LEAST 72 HOURS IN ADVANCE OF THE START OF CONSTRUCTION IN ANY NEW AREAS.
- 7. ALL MANHOLES, VALVE BOXES, MONUMENT BOXES, AND OTHER STRUCTURES IN THE PAVEMENT AREA SHALL BE ADJUSTED TO FINISH GRADE BEFORE PAVING FINAL LIFT.
- GRADE BREAKS ON CURBS AND SIDEWALKS ARE TO BE ROUNDED OFF ON FORM WORK AND FINISHED SURFACING.
- 9. IT IS THE CONTRACTOR'S RESPONSIBILITY TO REPLACE ALL SURVEY MONUMENTS OR CORNER PIPES DISTURBED DURING THE PROCESS OF CONSTRUCTION. IF A MONUMENT HAS THE POTENTIAL OF BEING DISTURBED, A CORNER RECORD SHALL BE FILED WITH THE COUNTY SURVEYOR (PER SECTION 8773.2 OF THE PUBLIC LAND SURVEYORS ACT) AS REQUIRED BY THE SUBDIVISION MAP ACT TO PRESERVE THE LOCATION OF SAID MONUMENT. CONTRACTOR SHALL, AT HIS/HER EXPENSE, HIRE A CIVIL ENGINEER OR LAND SURVEYOR TO PERFORM THE WORK.
- 10. ALL SURPLUS AND UNSUITABLE MATERIAL SHALL BE REMOVED FROM PROJECT SITE AND DISPOSED OF AT THE CONTRACTOR'S EXPENSE INCLUDING VEGETATION, SOILS, DEBRIS, AND MATERIALS.
- 11. CONTRACTOR SHALL PROVIDE ADEQUATE DUST CONTROL AND KEEP MUD AND DEBRIS OFF THE CAMPUS AND PUBLIC ROADS AT ALL TIMES.
- 12. ALL TRENCHES AND EXCAVATIONS SHALL BE CONSTRUCTED IN STRICT COMPLIANCE WITH THE APPLICABLE SECTIONS OF CALIFORNIA AND FEDERAL O.S.H.A. REQUIREMENTS AND OTHER APPLICABLE SAFETY ORDINANCES. CONTRACTOR SHALL BEAR FULL RESPONSIBILITY FOR TRENCH SHORING DESIGN AND INSTALLATION.
- 13. EXISTING UTILITIES SHOWN ARE BASED UPON RECORD INFORMATION AND ARE APPROXIMATE IN LOCATION AND DEPTH. THE CONTRACTOR SHALL POTHOLE ALL EXISTING UTILITIES THAT MAY BE AFFECTED BY NEW FACILITIES IN THIS CONTRACT, VERIFY ACTUAL LOCATION AND DEPTH, AND REPORT POTENTIAL CONFLICTS TO THE ENGINEER PRIOR TO EXCAVATING FOR NEW FACILITIES.
- 14. CONTRACTOR SHALL PERFORM CONSTRUCTION AND OPERATION IN A MANNER WHICH WILL NOT ALLOW HARMFUL POLLUTANTS TO ENTER THE STORM DRAIN SYSTEM. TO ENSURE COMPLIANCE, THE CONTRACTOR SHALL IMPLEMENT THE APPROPRIATE BEST MANAGEMENT PRACTICE (BMP) TO SUIT THE CONSTRUCTION SITE AND JOB
- OVERNIGHT PARKING OF CONSTRUCTION EQUIPMENT IN THE PUBLIC RIGHT-OF-WAY SHALL NOT BE PERMITTED CONTRACTOR SHALL USE DESIGNATED STAGING AREAS AND ANY OTHER AREAS AS AGREED TO IN WRITING BY OWNER'S REPRESENTATIVE.
- 16. ANY EXISTING UTILITIES TO BE REPLACED, EXCEPT THOSE SPECIFICALLY NOTED IN THE PLANS TO BE ABANDONED IN PLACE, SHALL BE EXCAVATED, REMOVED, PROPERLY DISPOSED OF OFFSITE, AND TRENCH BACKFILLED AND COMPACTED TO 95% MINIMUM COMPACTION. ANY UTILITIES TO BE ABANDONED IN PLACE SHALL BE FILLED WITH SAND OR CONTROL DENSITY FILL (CDF) AND PLUGGED AT EACH END WITH A 6" THICK WALL OF CLASS "A" P.C.C.
- 17. UNLESS OTHERWISE NOTED, CLASS 2 A.B. UNDER CURB, GUTTER, AND STREET SECTIONS PAVED WITH ASPHALT CONCRETE SHALL BE COMPACTED TO 95% RELATIVE COMPACTION (MINIMUM).

HAZARDOUS MATERIAL NOTES

- 1. SOME EXISTING PIPE MAY BE ASBESTOS CEMENT. CONTRACTOR TO PROPERLY HANDLE AND DISPOSE.
- 2. SEE SPECIFICATIONS FOR HAZMAT ABATEMENT PRIOR TO DEMOLITION.

EXCESS SOIL AND WASTE DISPOSAL

1. EXCESS CLEAN SOILS SHALL BE STOCKPILED IN THE SOIL STOCKPILE AREA SHOWN ON THE PLANS. EXCESS, CONCRETE, ASPHALT, VEGETATION, DEBRIS, AND OTHER WASTES SHALL BE DISPOSED APPROPRIATELY OFF SITE.

SURFACE RESTORATION

- IN ADDITION TO UTILITY AND VEGETATION RESTORATION, CONTRACTOR TO RESTORE SIDEWALKS, CURBS, PAVING, SLABS, STRIPING, SIGNAGE, AND OTHER SURFACE FEATURES TO PRE-PROJECT CONDITIONS.
- 2. NOT ALL SURFACE RESTORATION REQUIREMENTS SHOWN. CONTRACTOR TO ASSESS PRIOR TO BIDDING AND INCLUDE THE COST OF RESTORATION IN THE BID ITEMS AFFECTING SURFACE FEATURES

GEOTECHNICAL NOTES

- 1. THE DESIGN OF PROJECT WAS BASED ON FOLLOWING GEOTECHNICAL REPORTS:
- 1.1. GEOTECHNICAL AND GEOLOGIC HAZARD EVALUATION REPORT NEW GYMNASIUM LACO ASSOCIATES, MAY 1, 2020.
- 1.2. GEOTECHNICAL AND GEOLOGIC HAZARD EVALUATION REPORT NEW FIELDHOUSE LACO ASSOCIATES, DECEMBER 30, 2020.
- 1.3. ENGINEERING GEOLOGY AND SEISMOLOGY REVIEW FOR COLLEGE OF THE REDWOODS NEW GYMNASIUM LETTER FROM CALIFORNIA GEOLOGICAL SURVEY - JULY 28, 2020
- CALIFORNIA GEOLOGICAL SURVEY FEBRUARY 11, 2021

1.4. ENGINEERING GEOLOGY AND SEISMOLOGY REVIEW FOR COLLEGE OF THE REDWOODS - NEW GYMNASIUM - LETTER FROM


- 1.5. GEOTECHNICAL AND GEOLOGIC HAZARD EVALUATION REPORT, NEW FIELDHOUSE BUILDING RETAINING WALLS, COLLEGE OF THE REDWOODS, OCTOBER 24, 2022 - NOVEMBER 9, 2022
- 1.6. ADDENDUM TO GEOTECHNICAL AND GEOLOGIC HAZARD EVALUATION REPORT, NEW FIELDHOUSE BUILDING RETAINING WALLS, COLLEGE OF THE REDWOODS - DECEMBER 01, 2022
- 1.7. GEOTECHNICAL PEER REVIEW MEMORANDUM P.E. COMPLEX PROJECT, FIELDHOUSE SOLDIER PILE WALL, COLLEGE OF THE REDWOODS, HUMBOLDT COUNTY, CA - JANUARY 13, 2023
- 1.8. LACO RESPONSE TO THE CGS LETTER DATED JANUARY 13, 2022, REGARDING THIRD ENGINEERING GEOLOGY AND SEISMOLOGY REVIEW FOR COLLEGE OF THE REDWOODS – FIELDHOUSE RETAINING WALLS 7351 TOMPKINS HILL ROAD. EUREKA, CA. CGS APPLICATION NO. 01-CGS5316 COMMENTS - MARCH 13, 2023

CONSTRUCTION SEQUENCING NOTES

- 1. NOTE: CONTRACTOR TO MAINTAIN A FUNCTIONING CAMPUS UTILITY SYSTEM AT ALL TIMES.
- 2. ALL UTILITY INTERRUPTIONS AND CUTOVERS SHALL BE COORDINATED WITH THE OWNER AND SHALL TAKE PLACE WHEN CLASSES ARE NOT IN SESSION.

ITEMS TO BE PROVIDED BY CONTRACTOR

- 1. UNLESS SPECIFICALLY NOTED OTHERWISE, CONTRACTOR SHALL FURNIISH AND INSTALL ALL NEW ITEMS.
- 2. UNLESS SPECIFICALLY NOTED OTHERWISE THE TERM "PROVIDE" SHALL MEAN CONTRACTOR TO FURNISH AND INSTALL.

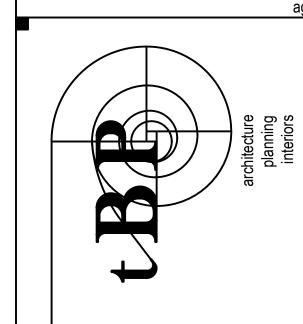






(J

TtBP project number: 22079.00 file name: 12609766-C-001_CIVIL NOTES drawn by: CSC / CP checked by: MD date: 12/5/2023 12/6/2023 BID SET THIS DRAWING AND THE DESIGNS. DEPICTIONS. IDEAS AND OTHER INFORMATION CONTAINED HEREIN CONSTITUTE UNPUBLISHED WORK OF tRP/ARCHITECTURE AND SHALL REMAIN PROPERTY OF tBP/ARCHITECTURE IN PERPETUITY. NO PART THEREOF SHALL BE REPRODUCED, DISCLOSED, DISTRIBUTED, SOLD, PUBLISHED OF OTHERWISE USED IN ANY WAY WITHOUT THE ADVANCED EXPRESS WRITTEN


CONSENT OF tBP/ARCHITECTURE drawing title: GENERAL NOTES


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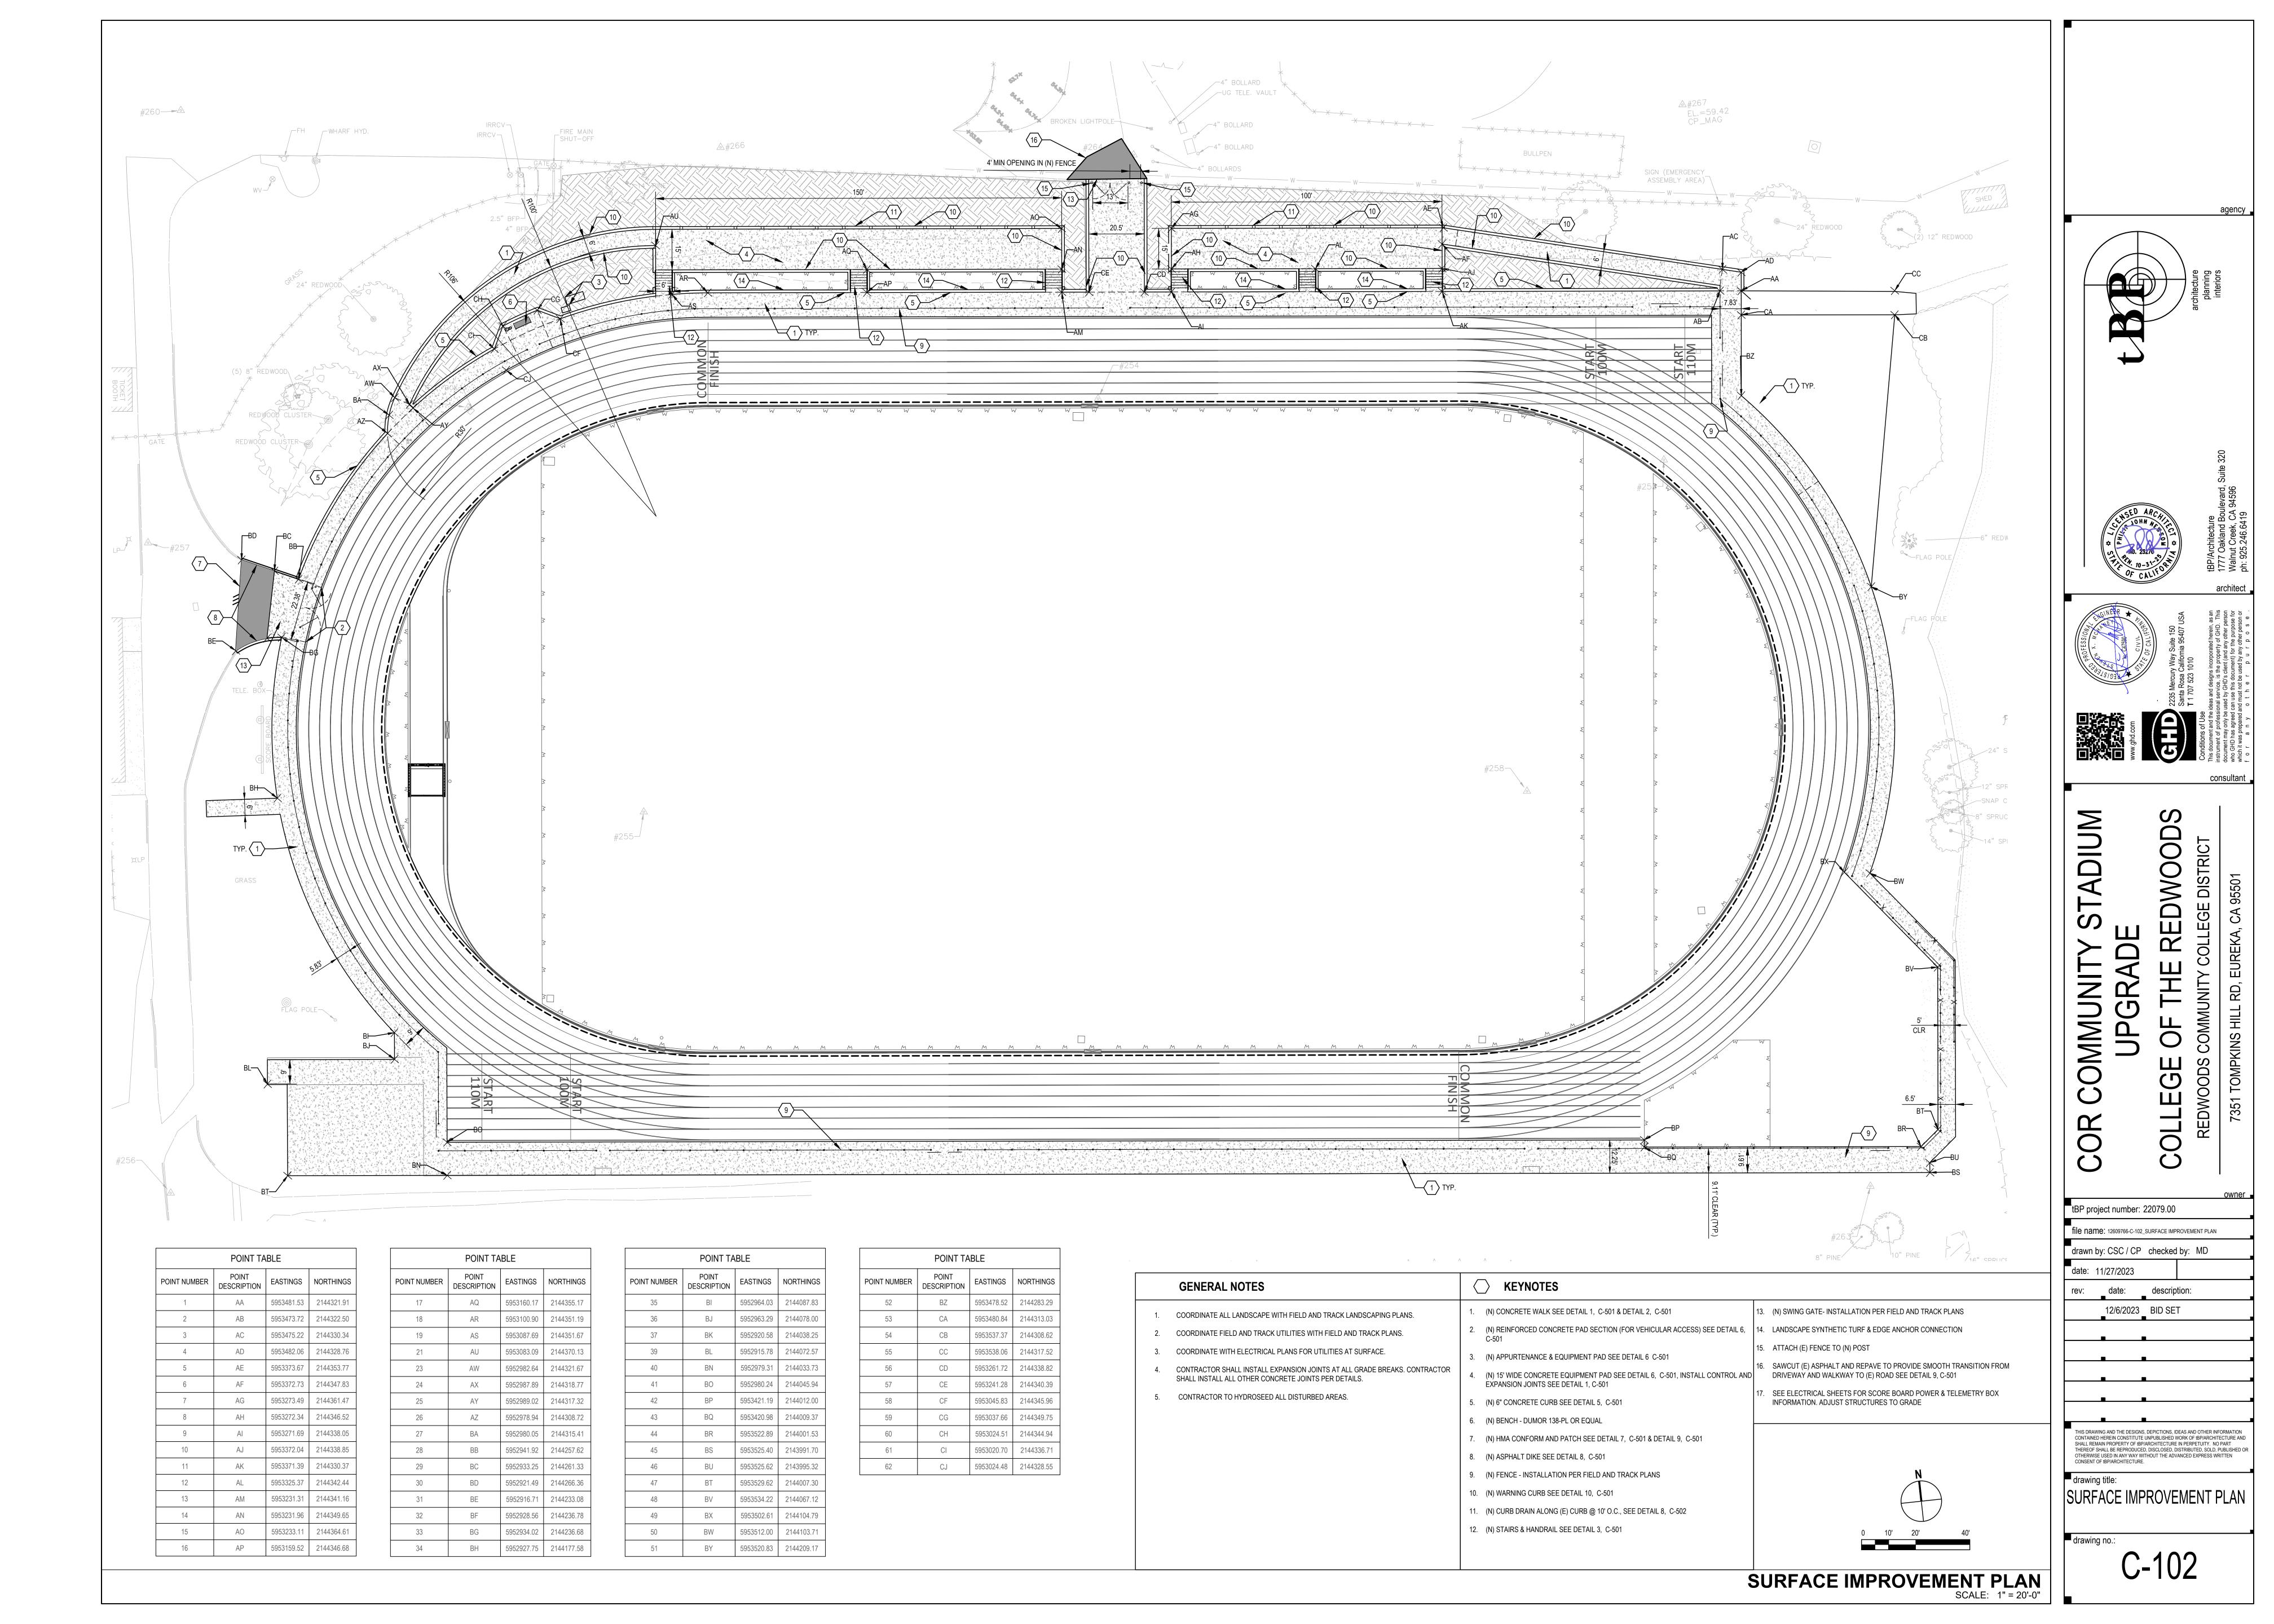


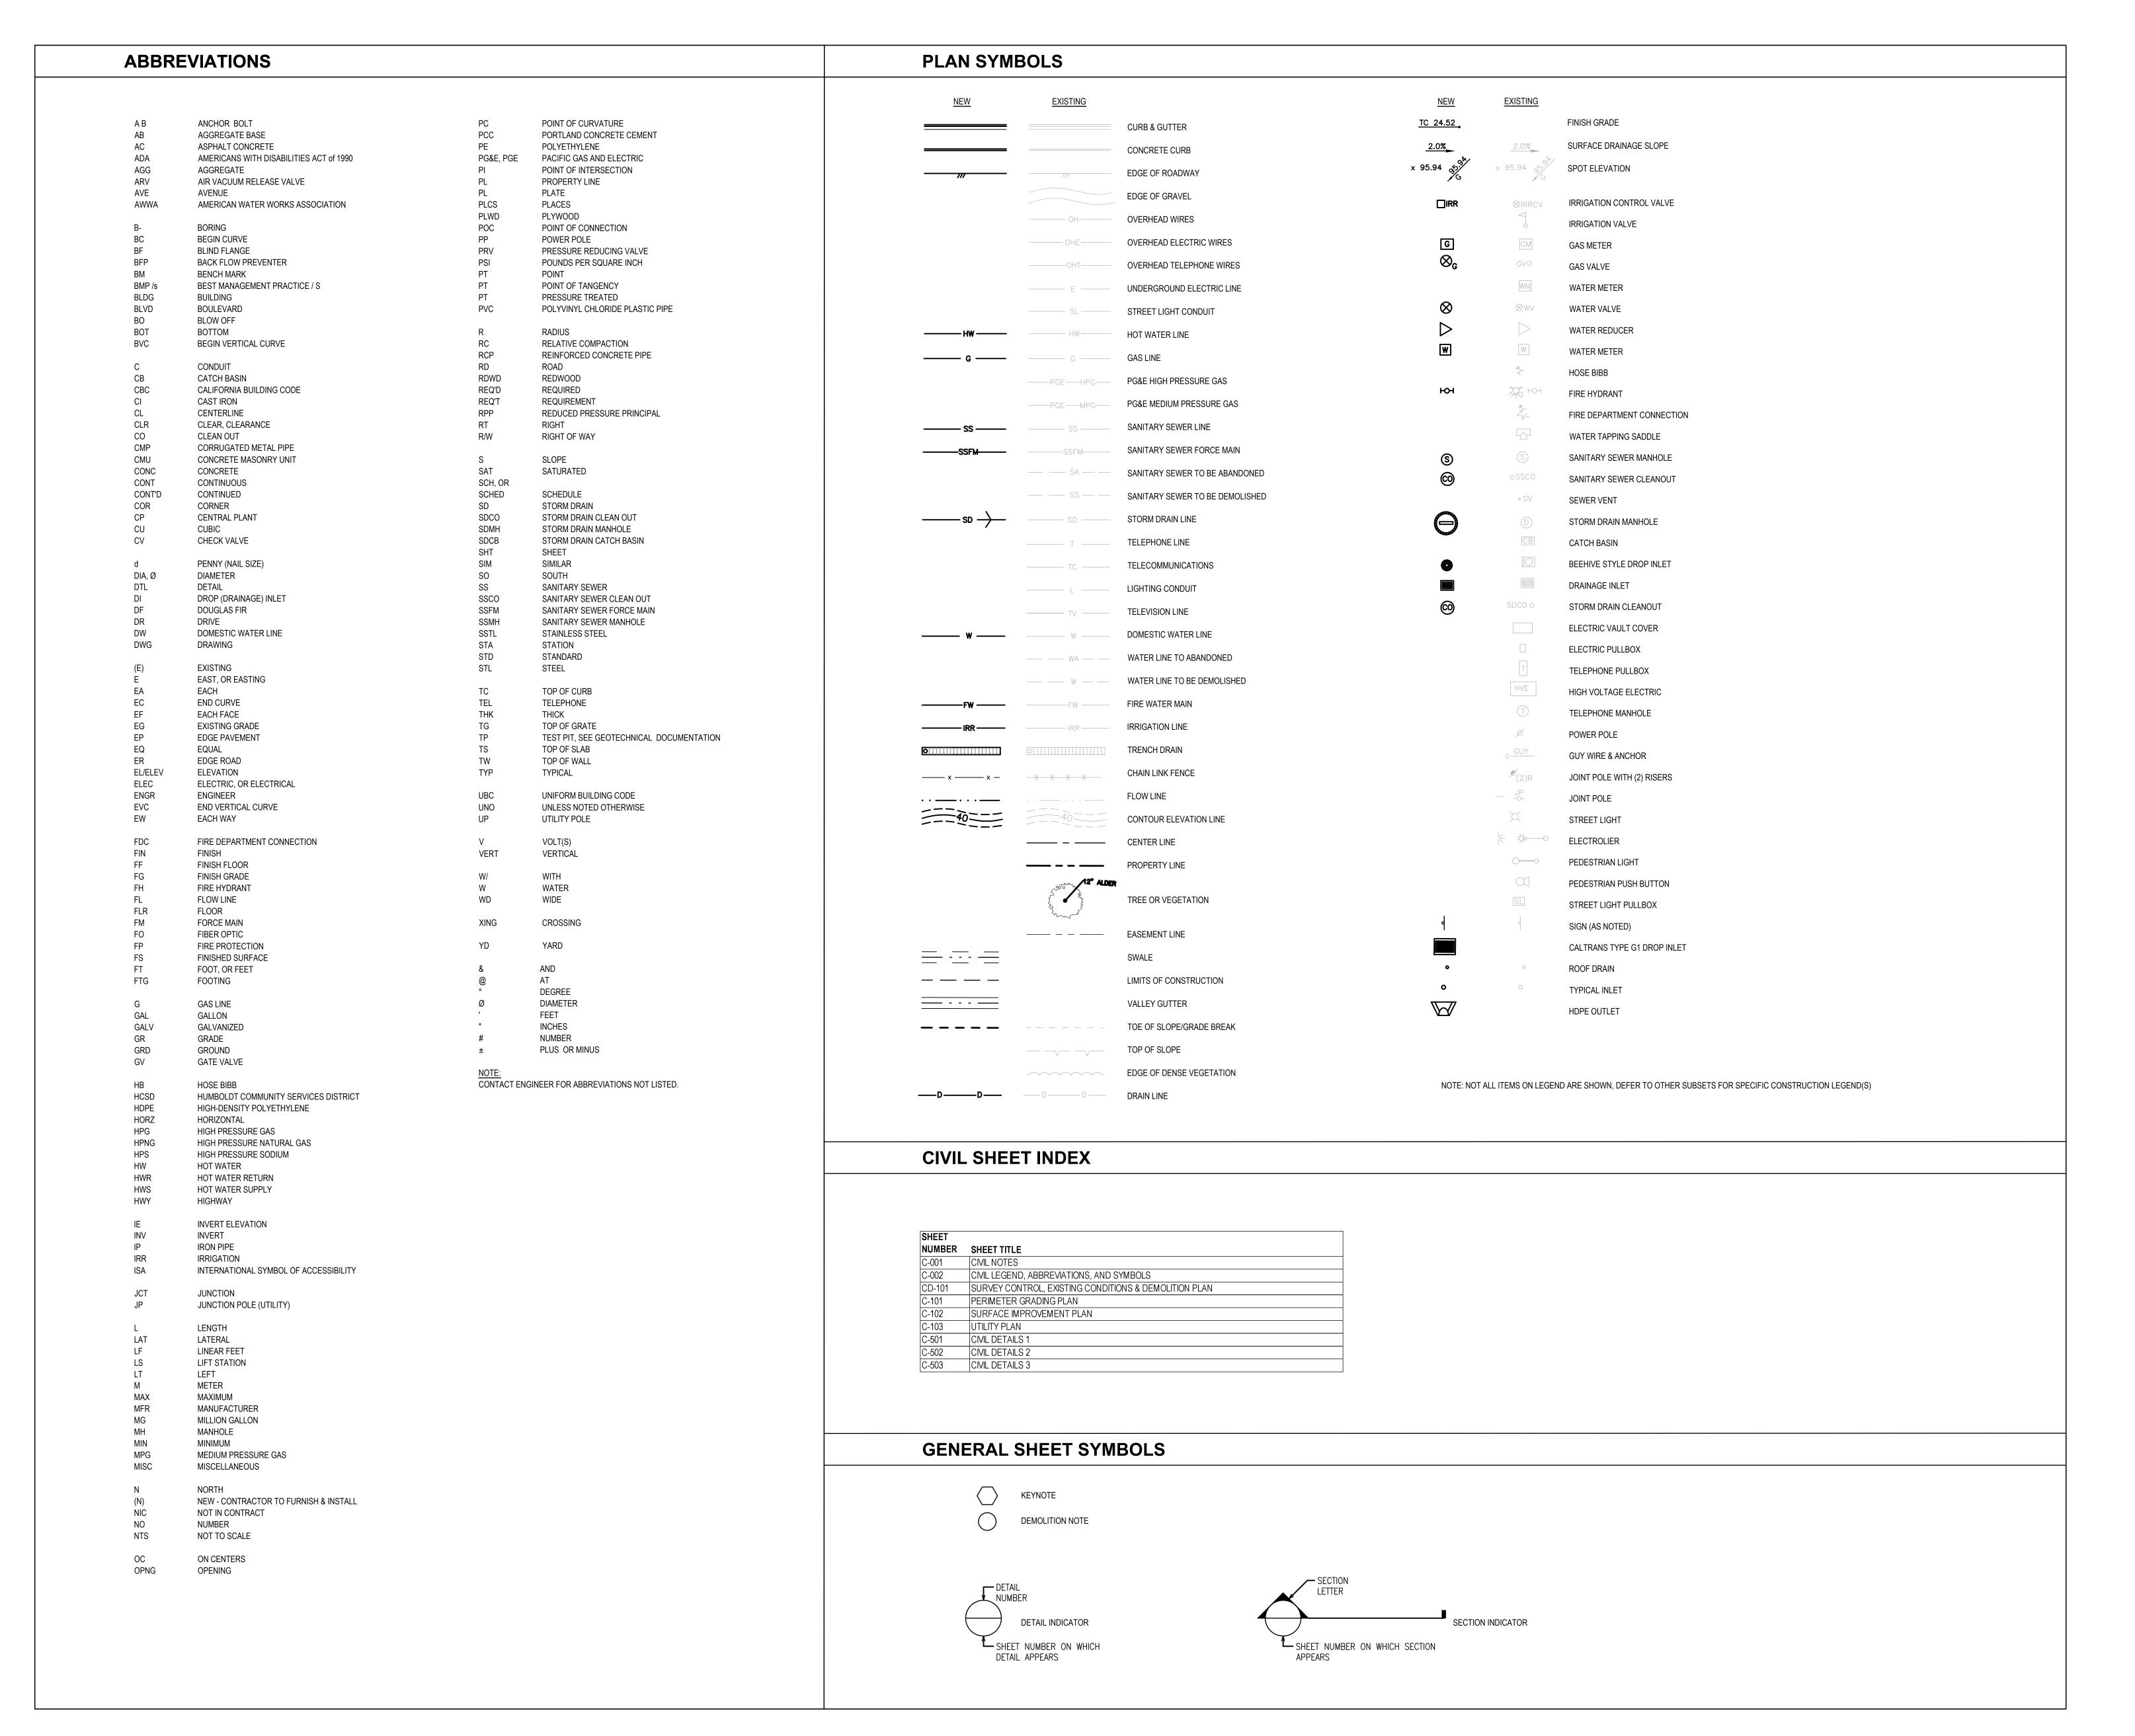


C-002



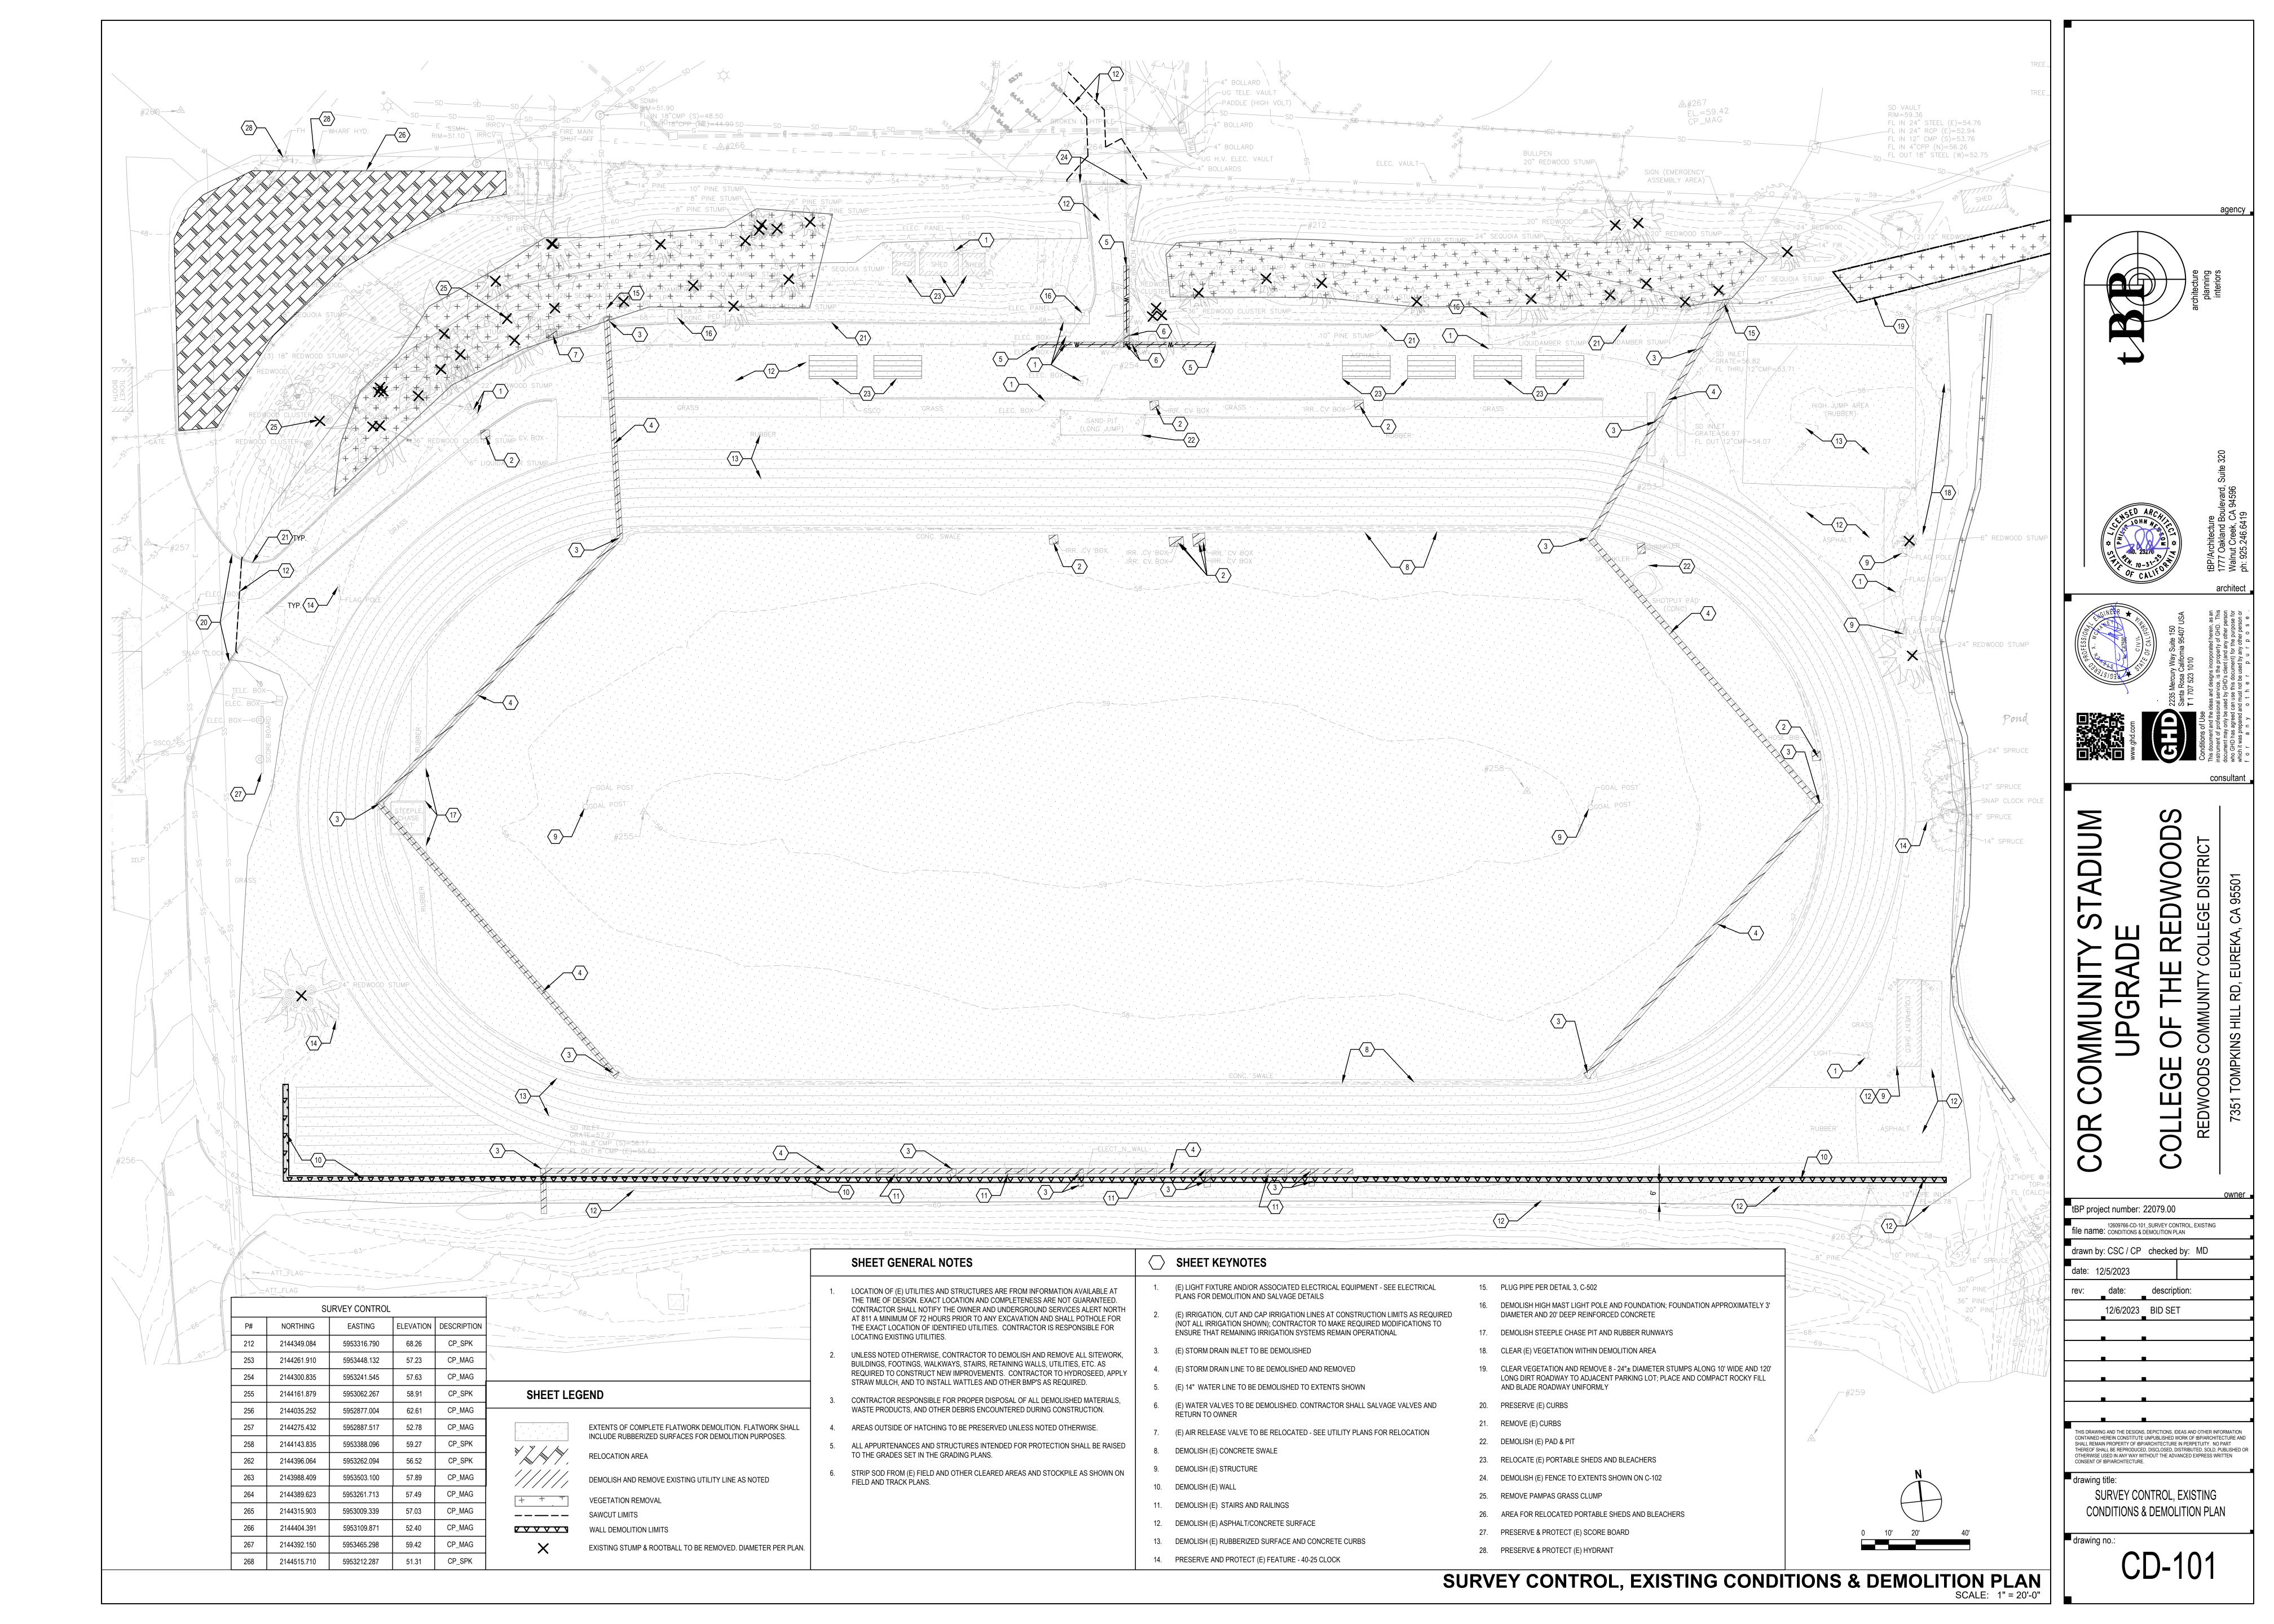


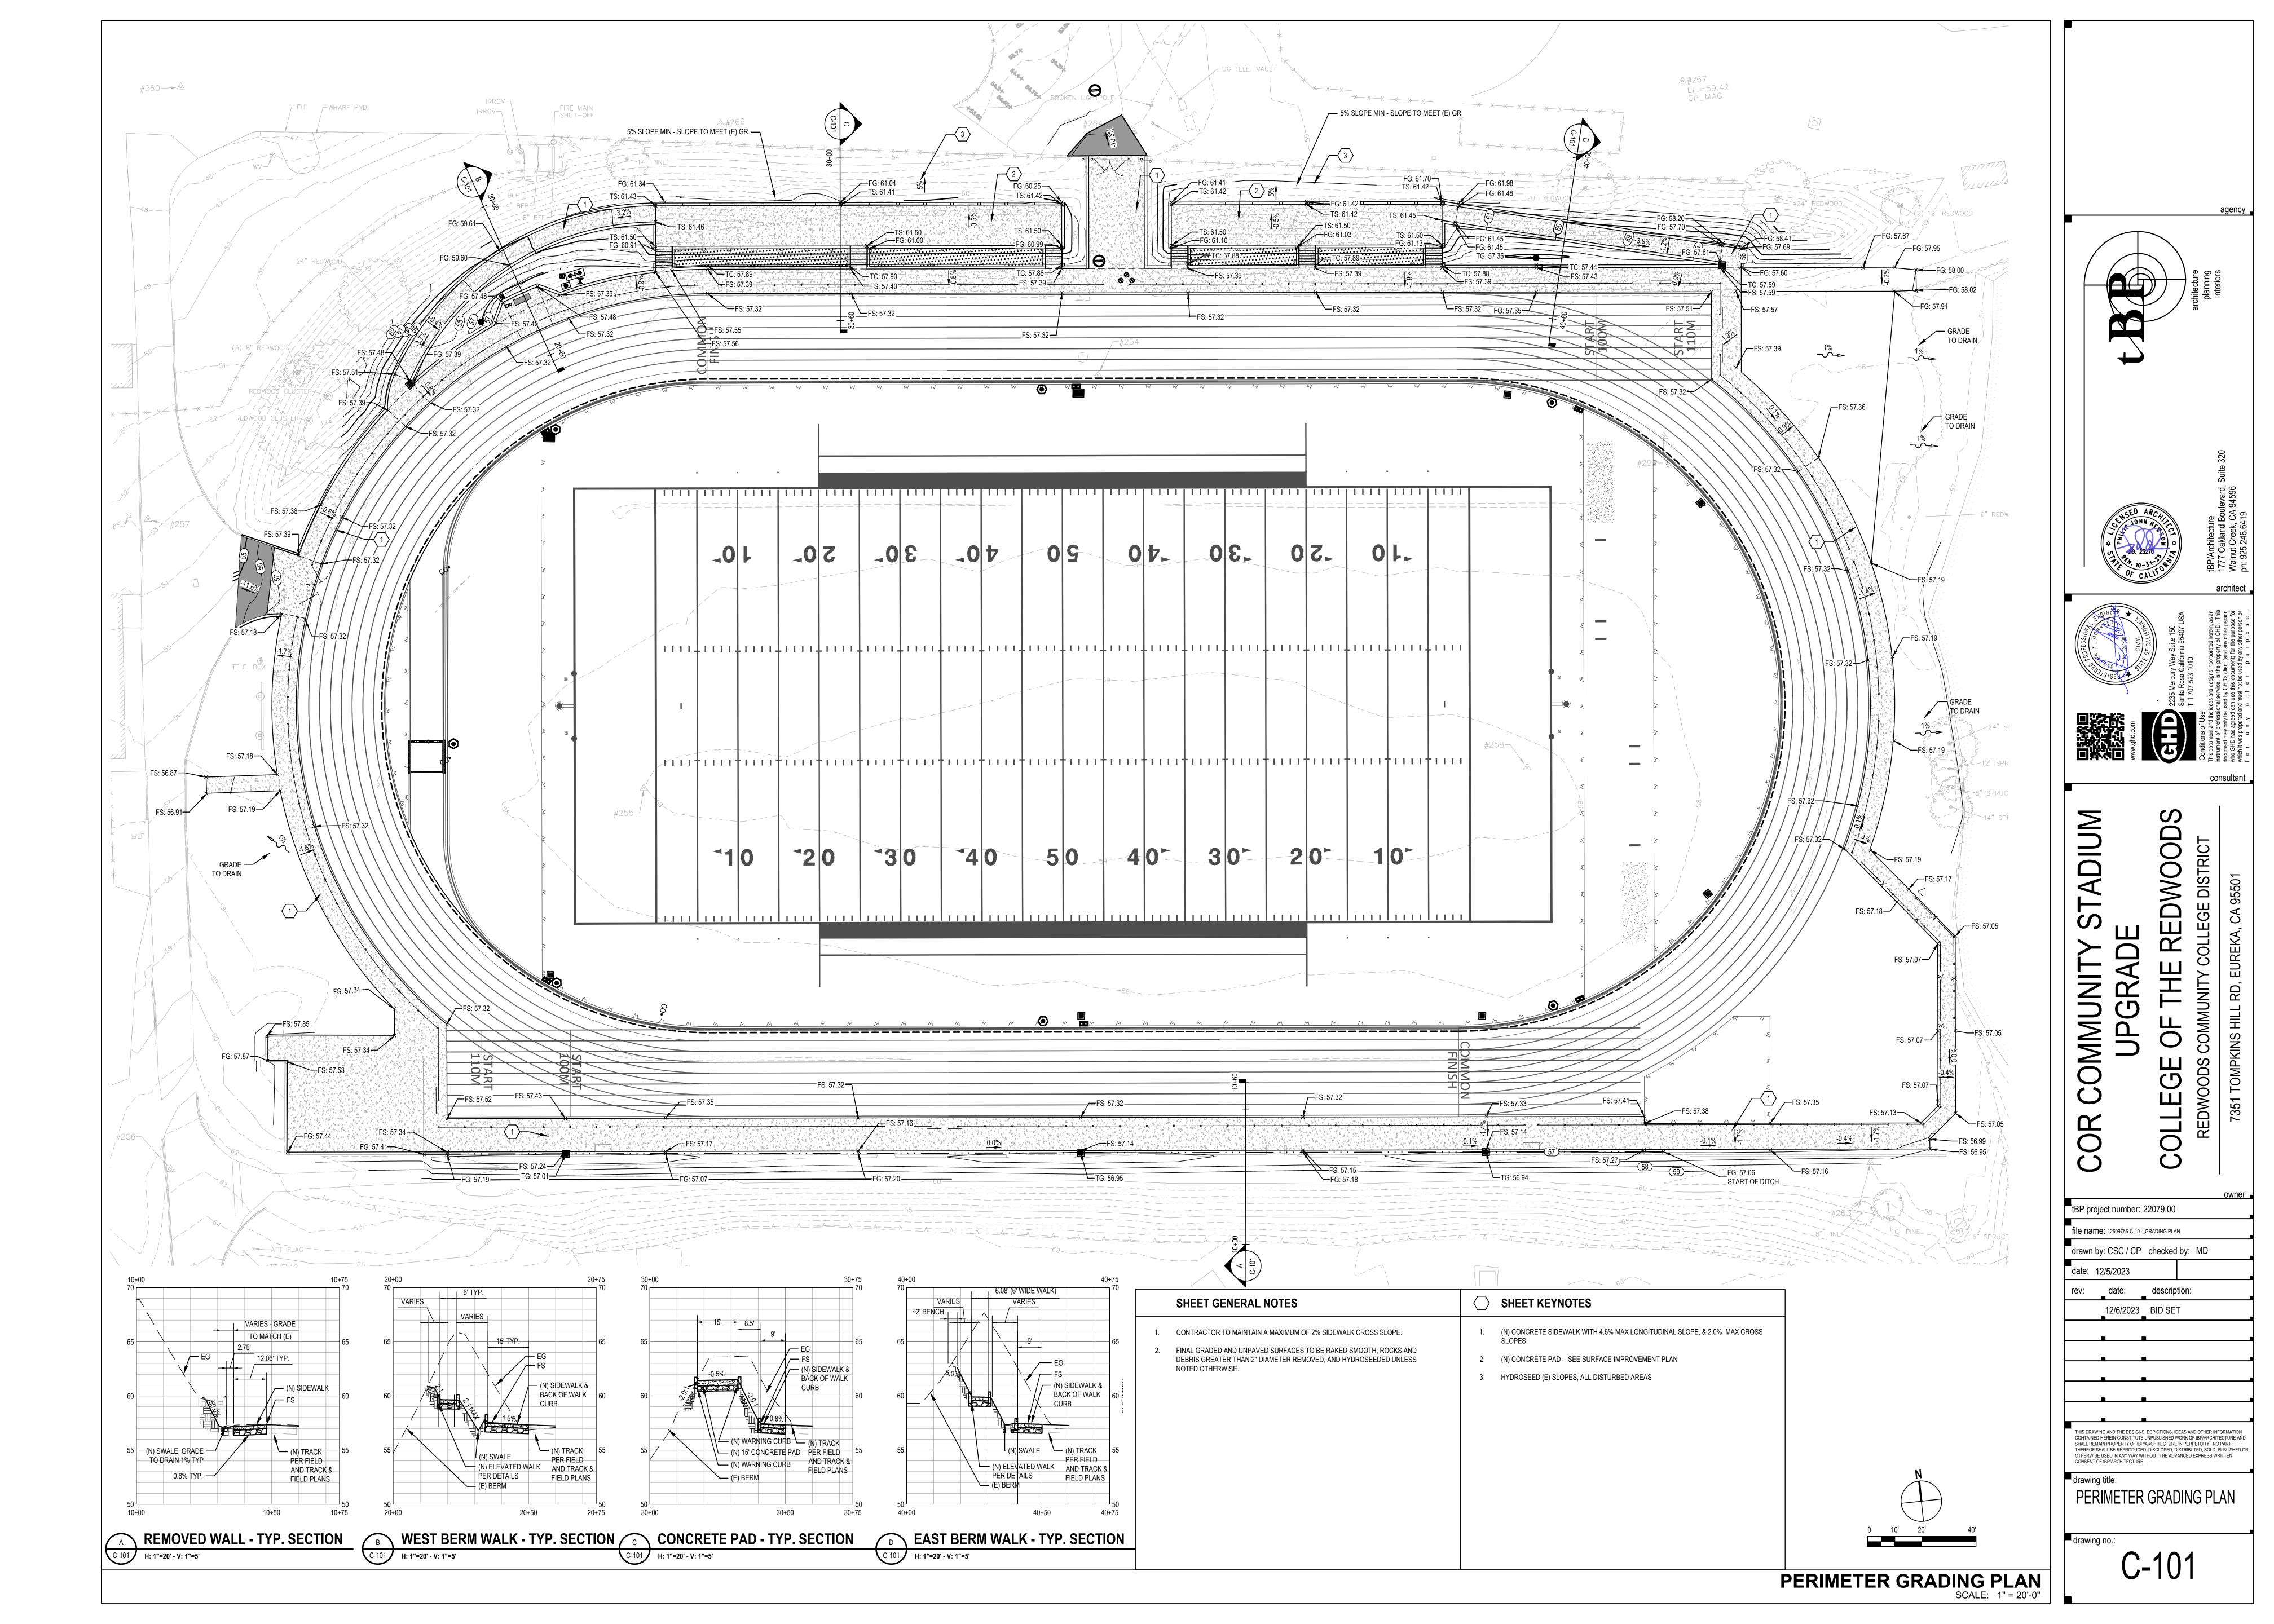

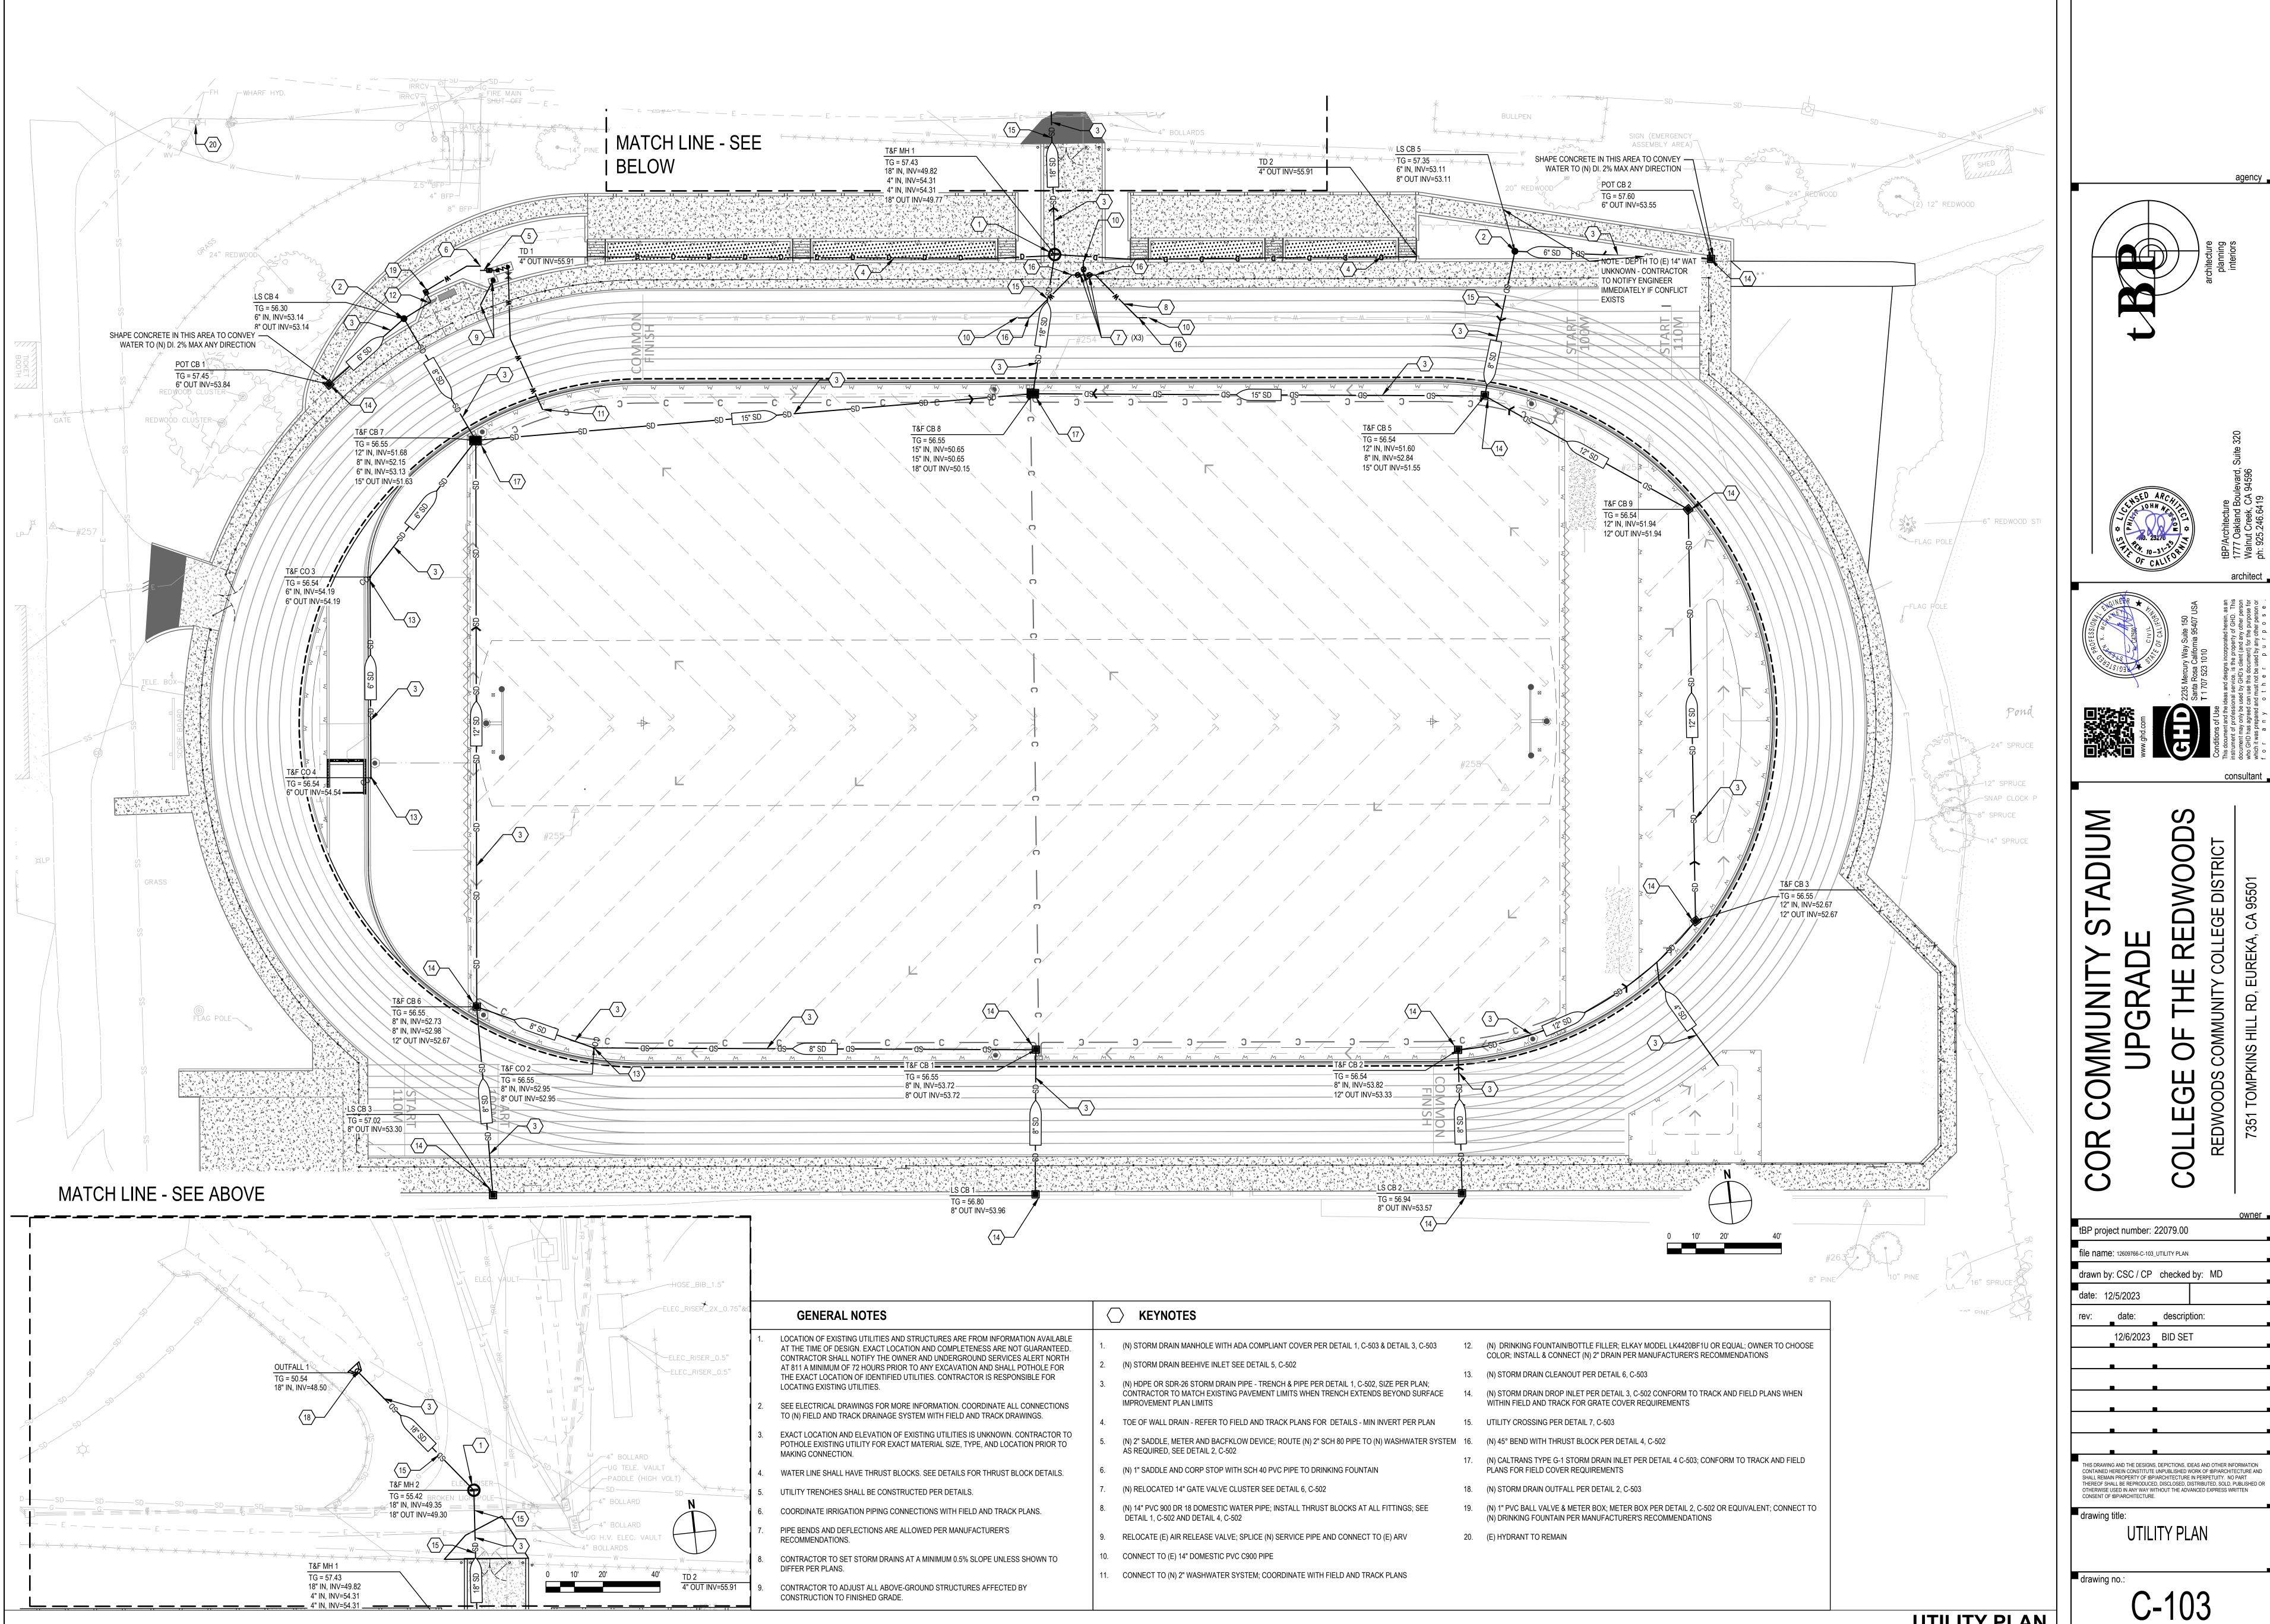



UTILITY PLAN SCALE: 1" = 20'-0"

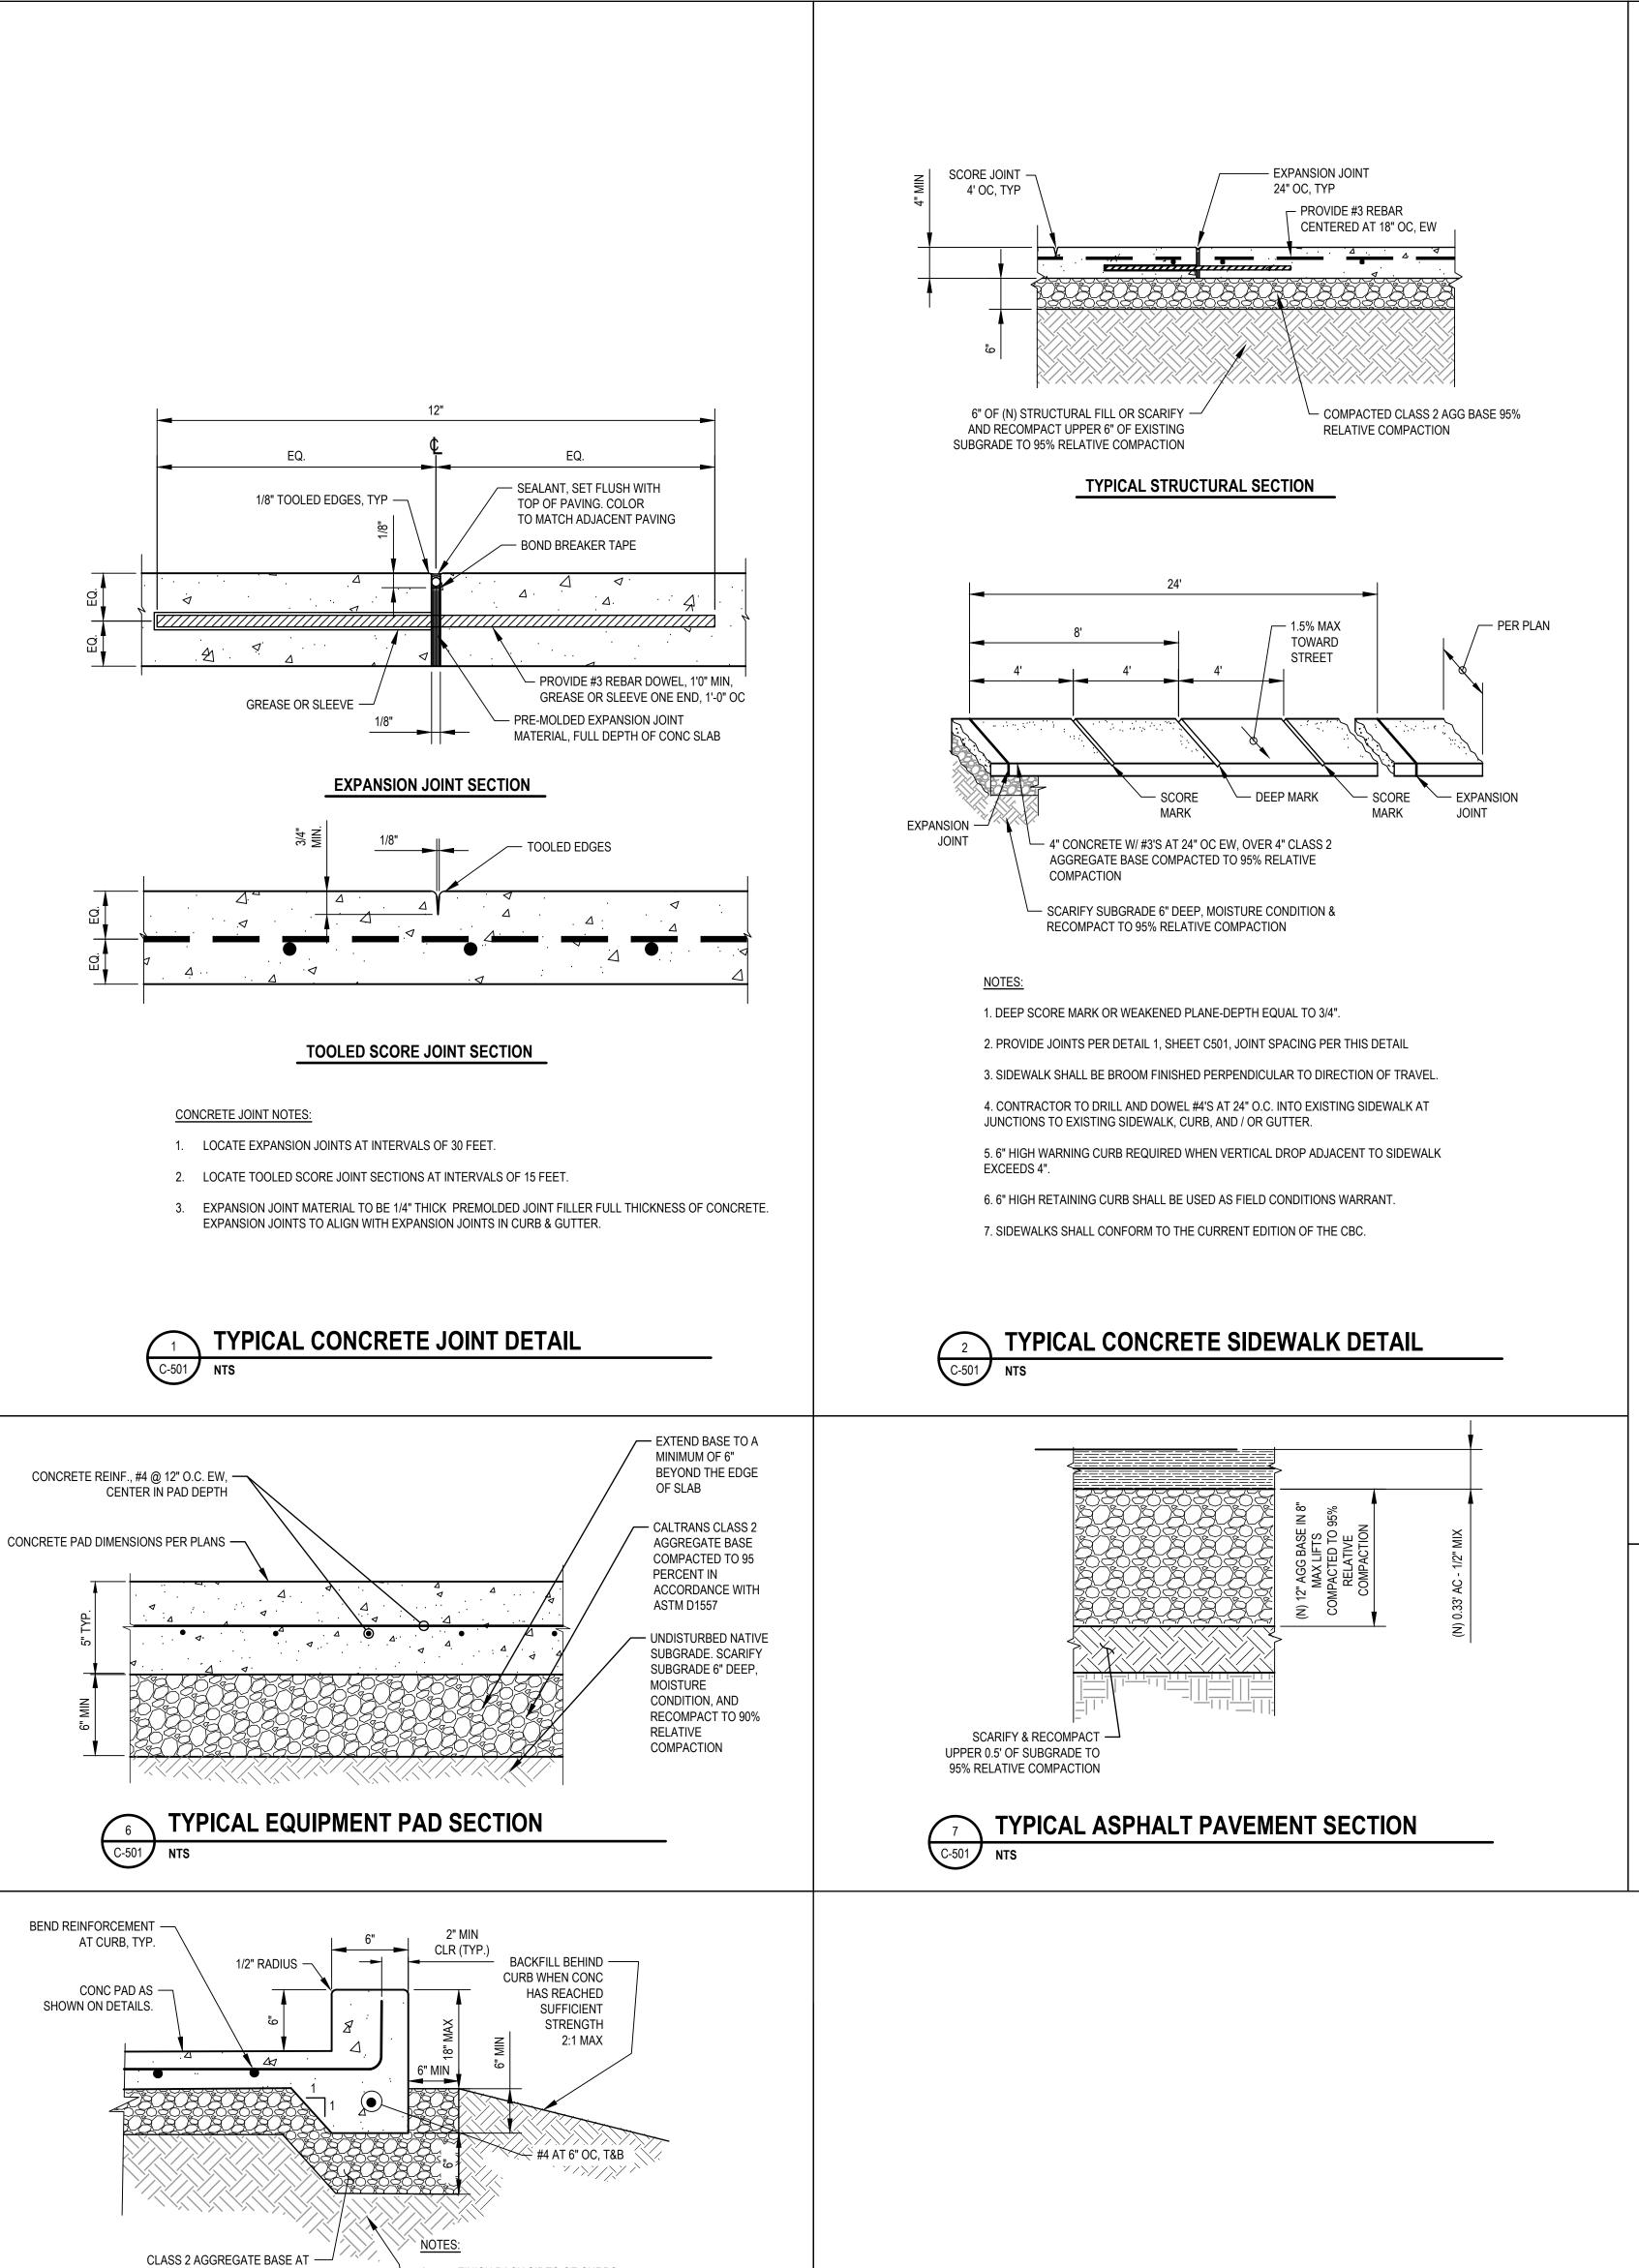

1. FINISH BACK SIDES OF CURBS.

95% RELATIVE COMPACTION

EQUIPMENT PAD SECTION


SCARIFY SUBGRADE 6" DEEP, MOISTURE —


CONDITION AND RECOMPACT


NOTE: NOT ALL REINFORCEMENT SHOWN. INCLUDE REINFORCEMENT PER TYPICAL

CONCRETE WARNING CURB DETAIL

TO 90% RELATIVE COMPACTION

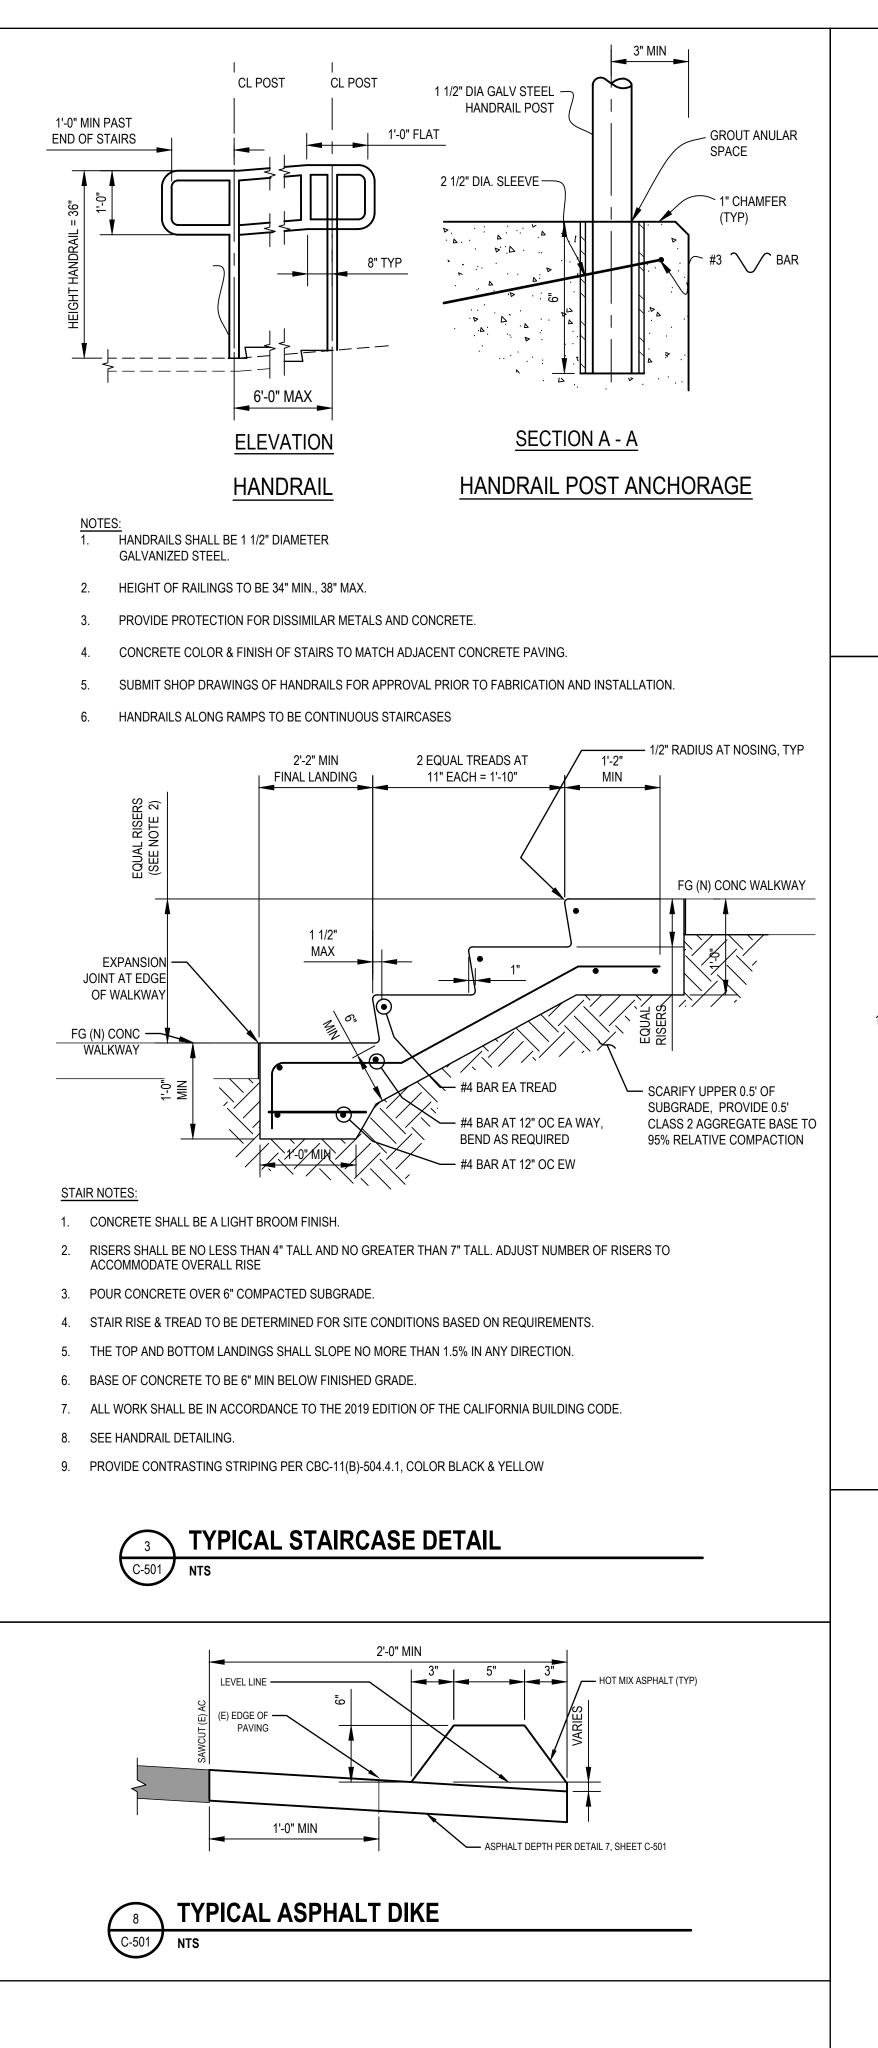

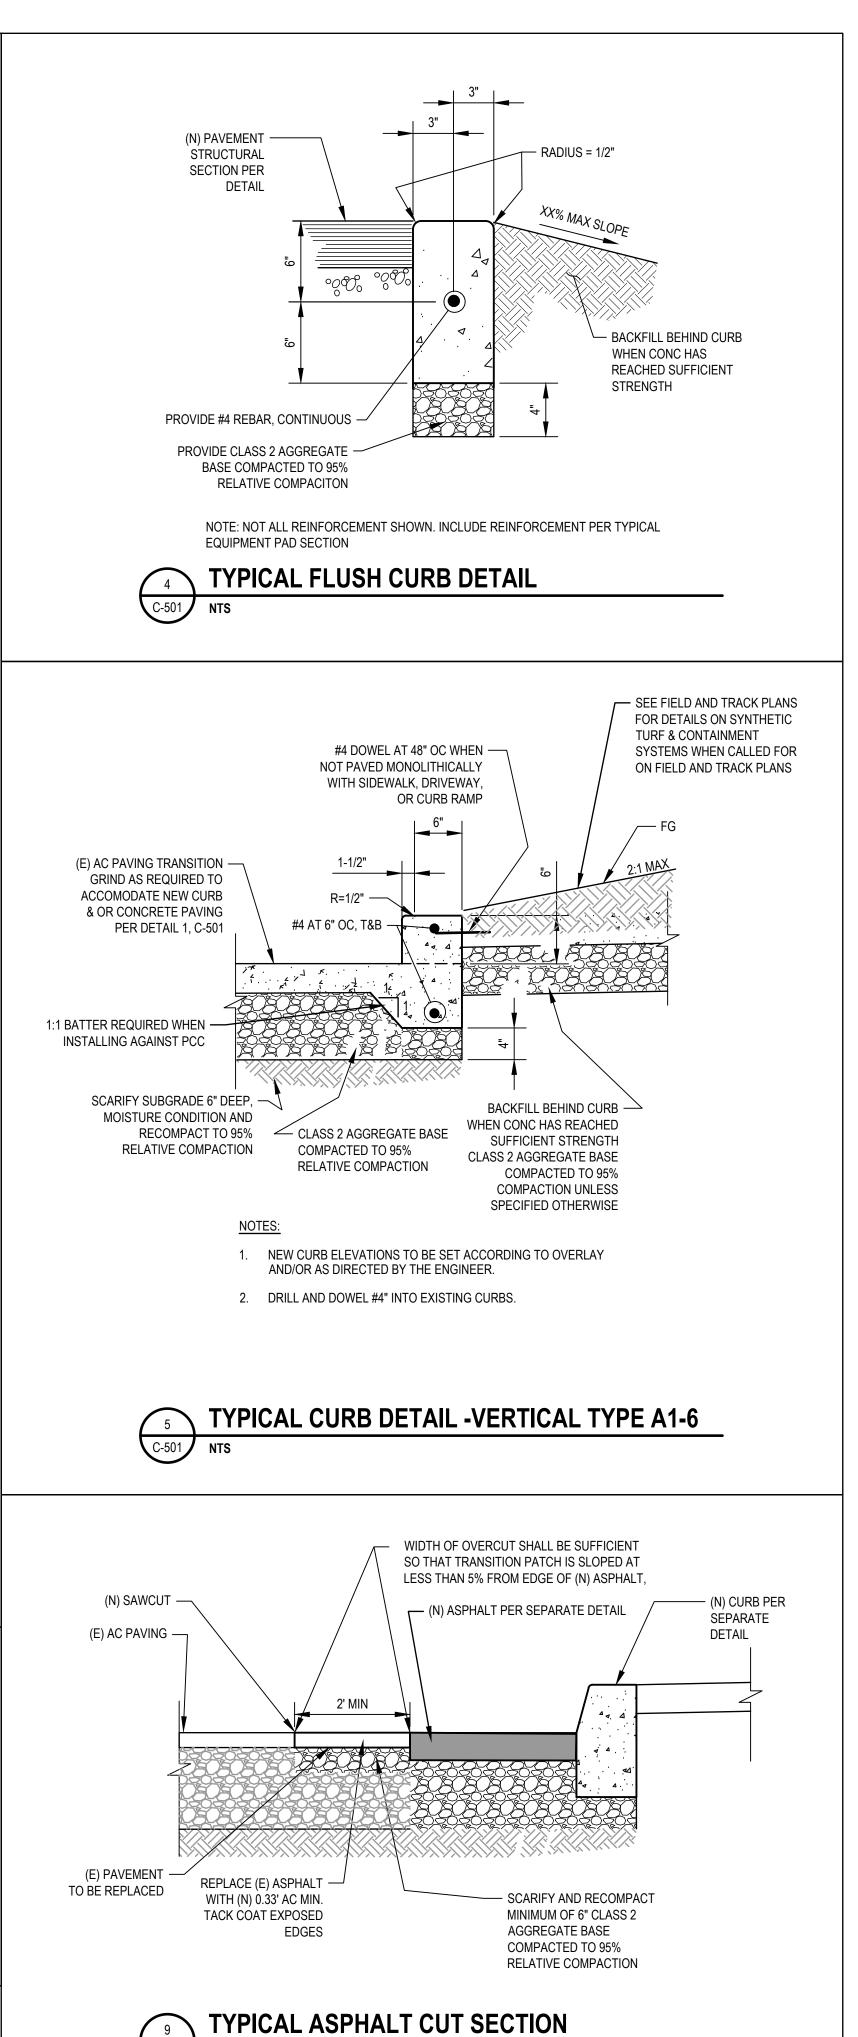

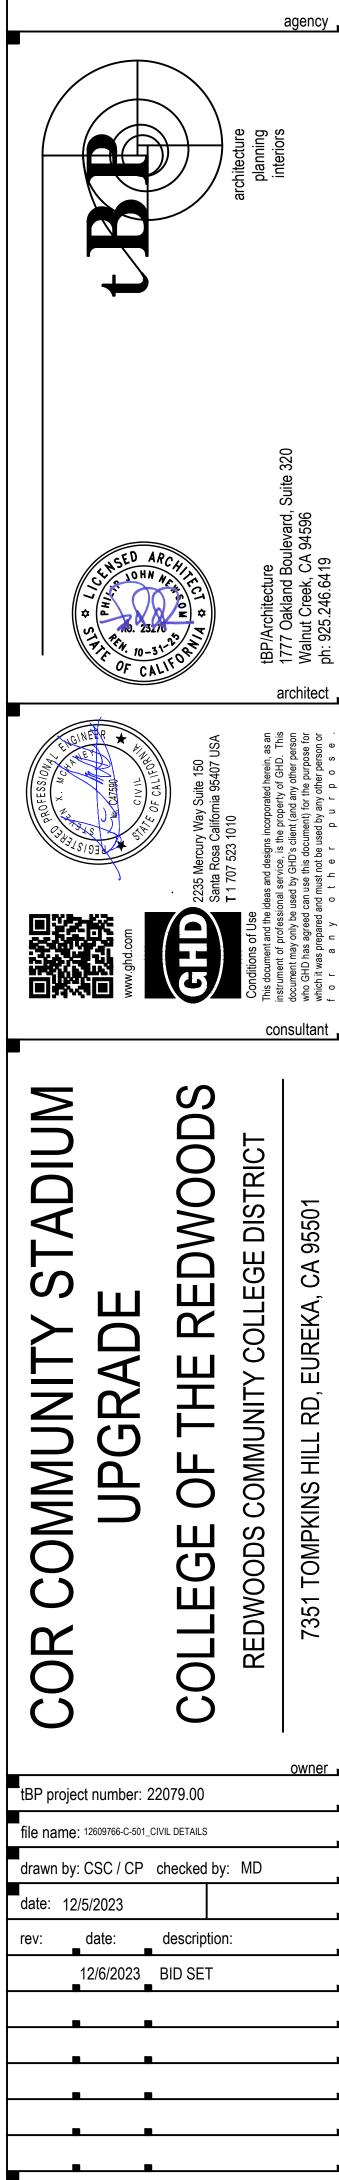


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CIVIL DETAILS 1

drawing no.:



- 2. DIFFERING TRENCH WIDTHS REQUIRE PRIOR APPROVAL OF ENGINEER.
- 3. IN MAKING EXCAVATIONS FOR THIS PROJECT, THE CONTRACTOR SHALL BE FULLY RESPONSIBLE FOR PROVIDING & INSTALLING ADEQUATE SHEETING, SHORING & BRACING AS MAY BE NECESSARY AS A PRECAUTION AGAINST SLIDES OR CAVE-INS, AND TO PROTECT ALL (E) IMPROVEMENTS OF ANY KIND, EITHER ON PUBLIC OR PRIVATE PROPERTY, FULLY FROM DAMAGE.
- 4. SATISFACTORY NATIVE BACKFILL MATERIAL USED AS UTILITY TRENCH BACKFILL BELOW UNPAVED AREAS SHALL BE APPROVED BY THE ENGINEER PRIOR TO USE.
- 5. 2-SACK SLURRY BACKFILL MAY BE USED IN TRENCH WHEN MINIMUM PIPE COVER NOT POSSIBLE, WHEN APPROVED BY OWNER'S REPRESENTATIVE.
- 6. DETECTABLE WARNING TAPE SHALL BE BRIGHT COLORED, CONTINUOUSLY PRINTED, MINIMUM 6" WIDE BY 4 MIL. THICK, MANUFACTURED
- 7. DETECTABLE WARNING TAPE NOT REQUIRED FOR IRRIGATION LINES.

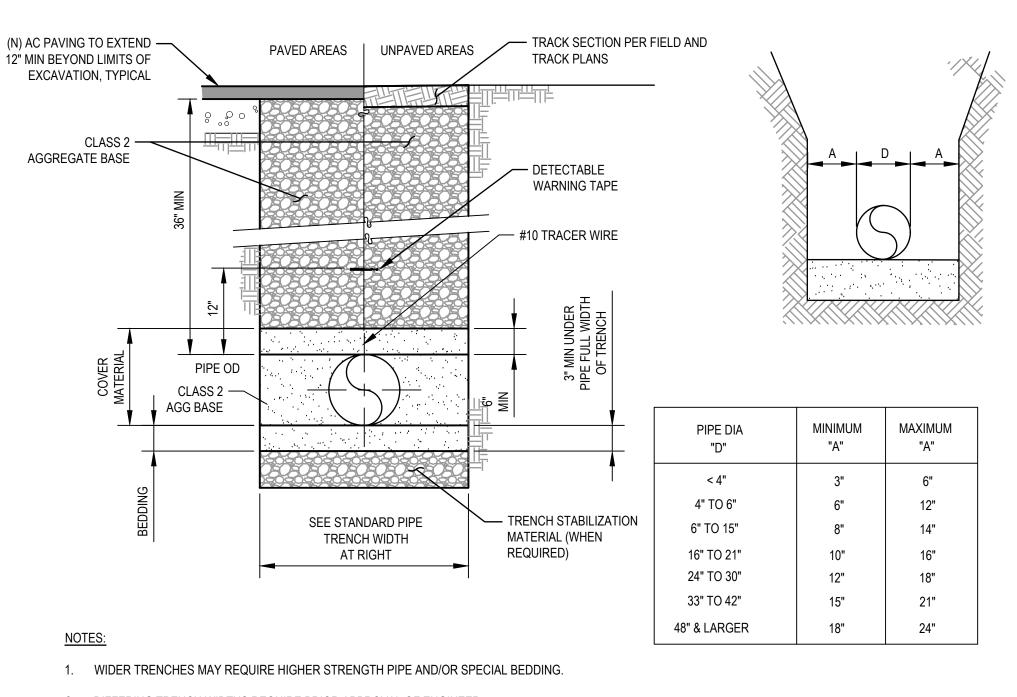CONCRETE THRUST BLOCKS ARE TO BE POURED AGAINST UNDISTURBED EARTH OR

STRUCTURAL BACKFILL.THRUST BLOCKS ARE NOT REQUIRED WHERE JOINTS ARE

VOLUMES AND SPECIAL BLOCKING DETAILS SHOWN ON THE PLANS TAKE PRECEDENCE

ALL BURIED PIPE EXCEPT FLANGED, SCREWED, SOLVENT WELDED PVC OR WELDED STEEL

PIPE SPECIFIED TO BE PRESSURE TESTED SHALL BE PROVIDED WITH CONCRETE THRUST

THRUST BLOCKS SHALL NOT BE LOCATED OR SIZED TO ENCASE ADJACENT PIPES OR

THE BEARING AREAS ARE BASED ON TEST PRESSURE OF 150 PSI AND ALLOWABLE SOIL

DIFFERENT TEST PRESSURES AND SOIL BEARING STRESSES, USE THE FOLLOWING

8. THRUST BLOCKS REQUIRED AT ALL CHANGES IN DIRECTION OF PIPING UNLESS NOTED

BEARING STRESS OF 1000 POUNDS PER SQUARE FOOT. TO COMPUTE BEARING AREAS FOR

6. THE SIZE AND WEIGH OF ALL UPLIFT THRUST BLOCKS SHALL BE AS DETERMINED BY

OVER VOLUMES AND BLOCKING DETAILS SHOWN ON THIS STANDARD DETAIL.

BLOCKS AT ALL DIRECTIONAL CHANGES UNLESS OTHERWISE NOTED.

FOR DIRECT BURIAL.

ADEQUATELY RESTRAINED.

KEEP CONCRETE CLEAR OF JOINTS AND ACCESSORIES.

BEARING AREA = (TEST PRESSURE / 150) x (1000 / SOIL BEARING STRESS) x (TABLE VALUE)


9. CONTRACTOR TO PROVIDE ALL COMPONENTS.


10. ALL PIPE AND FITTINGS SHALL BE WRAPPED IN

CONC ADHESION.

POLYETHYLENE TO PREVENT CORROSION AND



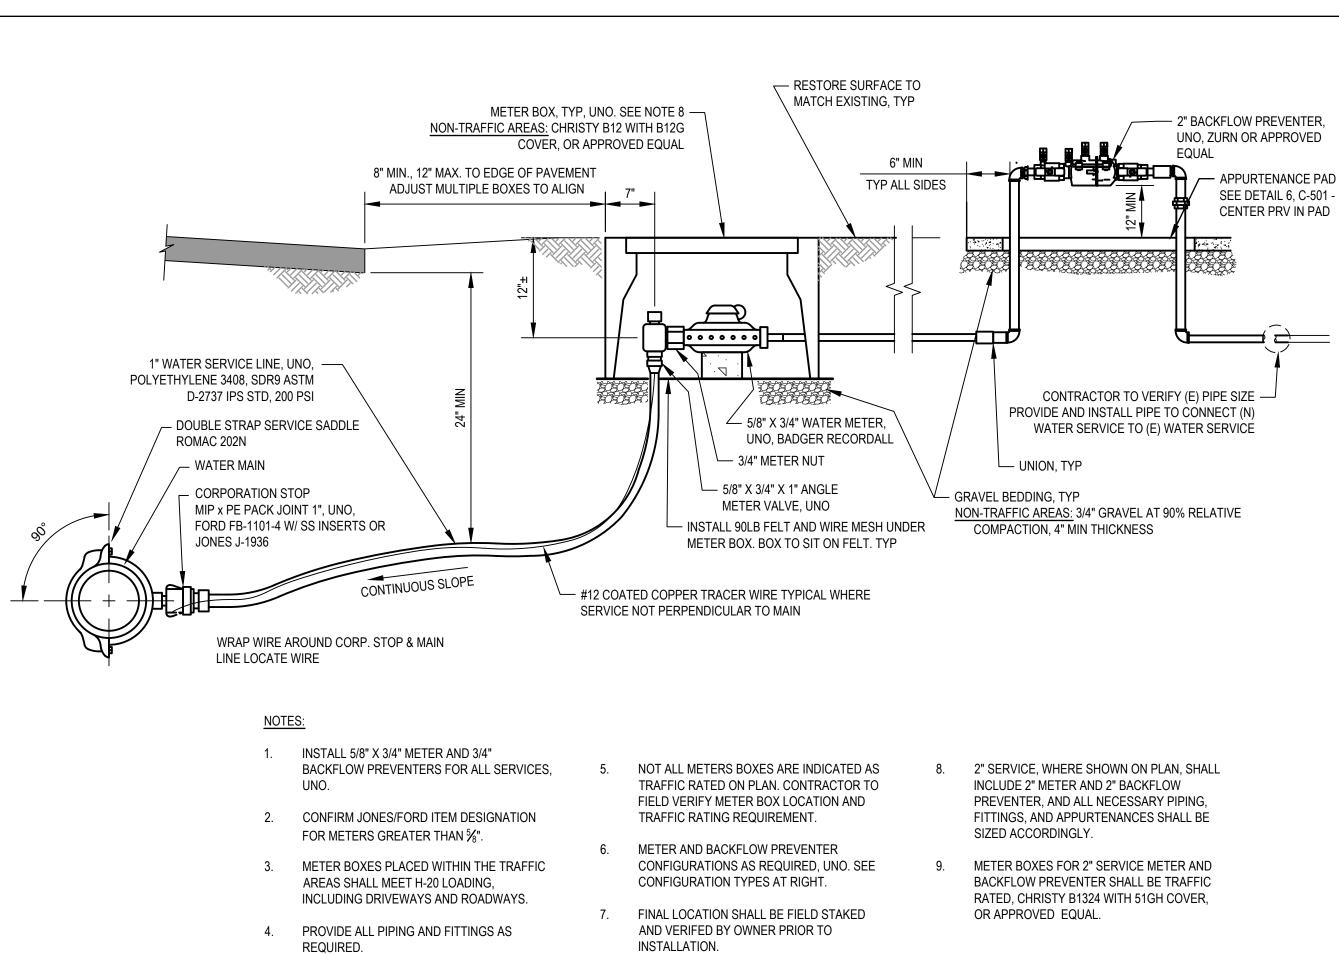

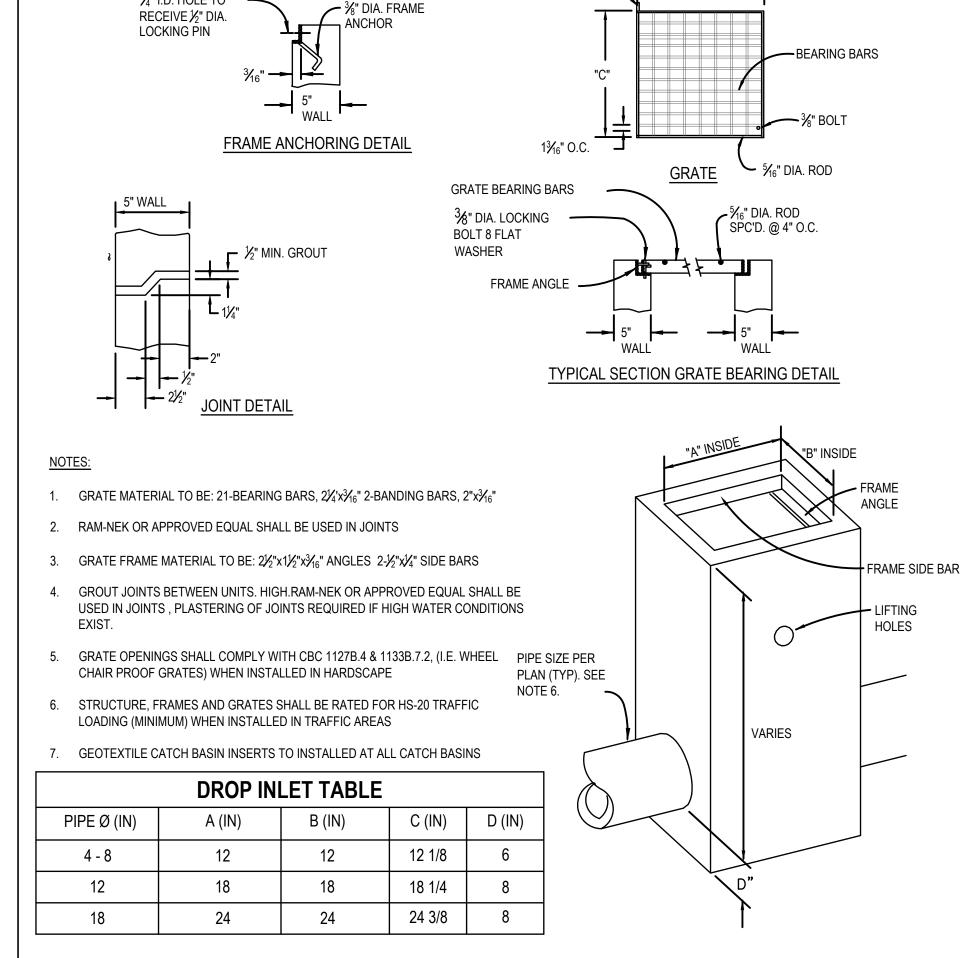



PRECAST STORM DRAIN INLET DETAIL

½" LOCKING PIN

 $\frac{3}{4}$ " I.D. HOLE TO



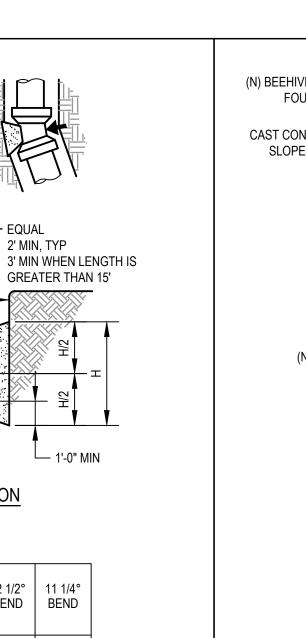

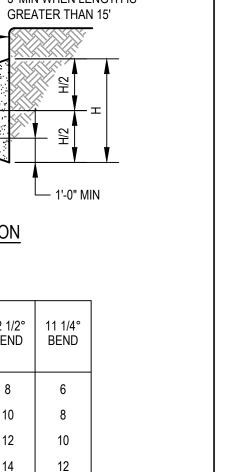



				E	BEARIN	IG ARE	A OF TH	RL	JST BL	OCK IN SQ	. FT.					
PIPE SIZE	TEE, WYE, PLUG OR	90° BEND PLUGGED	PLU	EE GGED	45° BEND	22 1/2° BEND	11 1/4° BEND		PIPE SIZE	TEE, WYE, PLUG OR	90° BEND PLUGGED	T PLU	EE GGED	45° BEND	22 1/2° BEND	11 1/4° BEND
OIZL	CAP	CROSS	A1	A2	52.12	52.12	525		OIZL	CAP	CROSS	A1	A2	32.12	52.12	
4	1.5	2	2	1.5	1.5	1	1		18	19	27	27	19	15	8	6
6	3	4.5	4.5	3	2.5	1.5	1		20	24	34	34	24	18	10	8
8	5	7	7	5	4	2	1		22	29	41	41	29	22	12	10
10	8	12	12	8	7	3	2		24	34	48	48	34	26.5	14	12
12	12	17	17	12	10	5	3		32	39	55	55	39	31.5	16	14
16	15	21.5	21.5	15	12	6	4									


2500 PSI MIN CONC. USE STEEL -

WHERE LENGTH IS 9' OR MORE

(3-#5 HORIZ/ #4 AT 18" VERT)

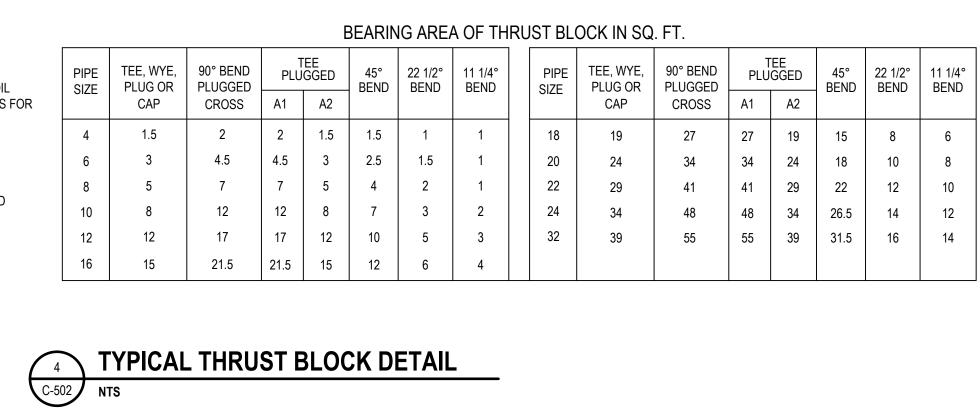

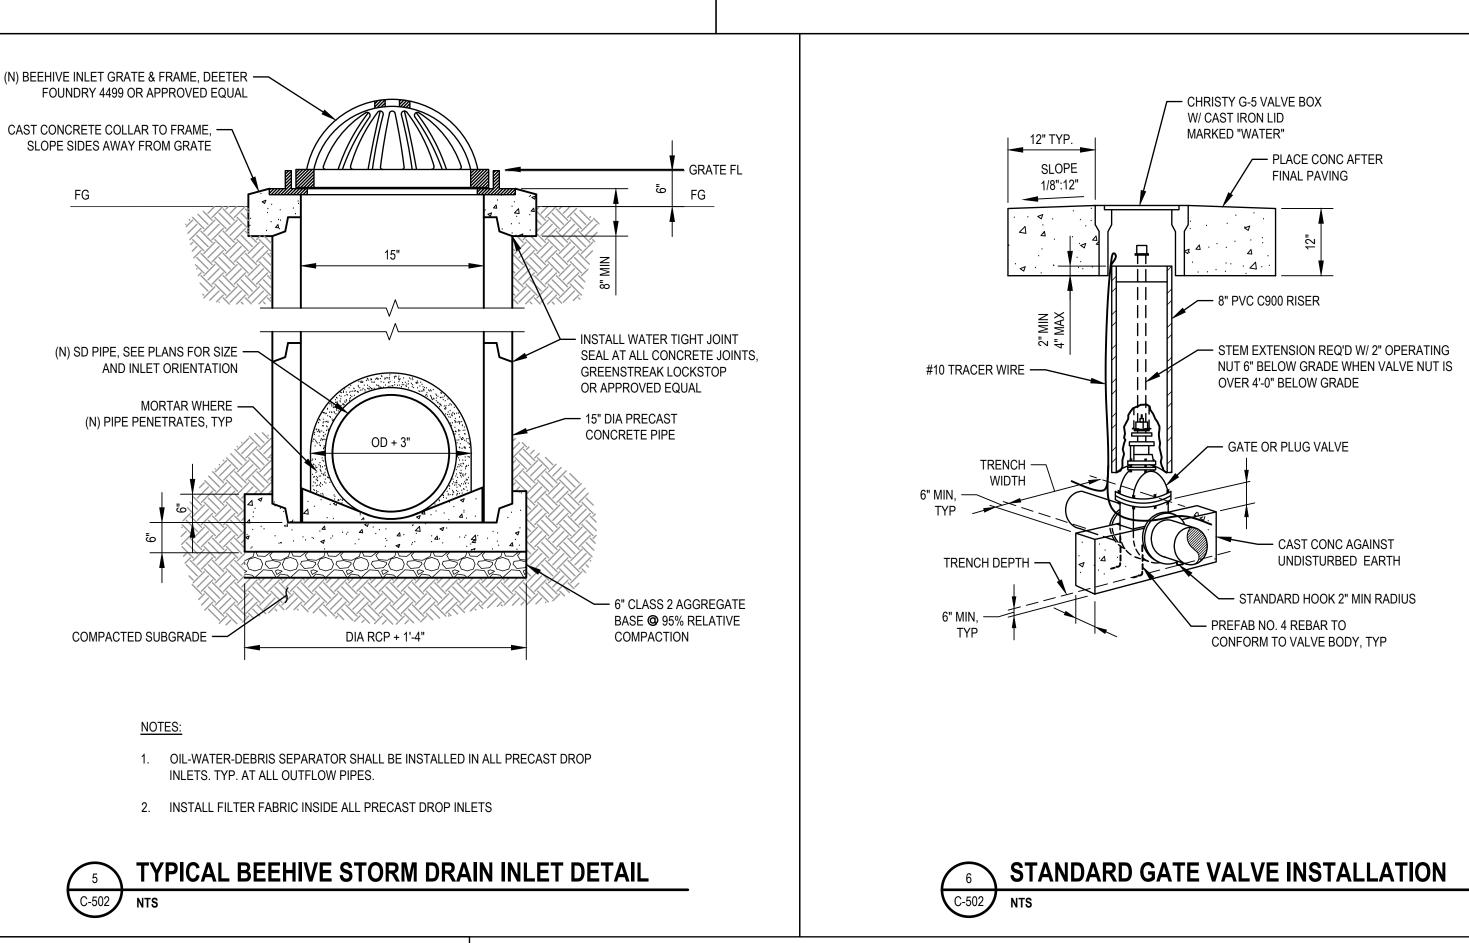

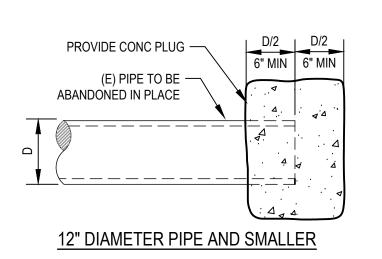


PIPE PLUGS SHALL BE INSTALLED TO THE SATISFACTION OF THE OWNER'S

2. SHALL BE INSPECTED BY THE OWNER'S REPRESENTATIVE BEFORE

ELEVATION


3. SMALLER PIPES MAY BE CAPPED.


7 PLUG AND ABANDON EXISTING PIPE

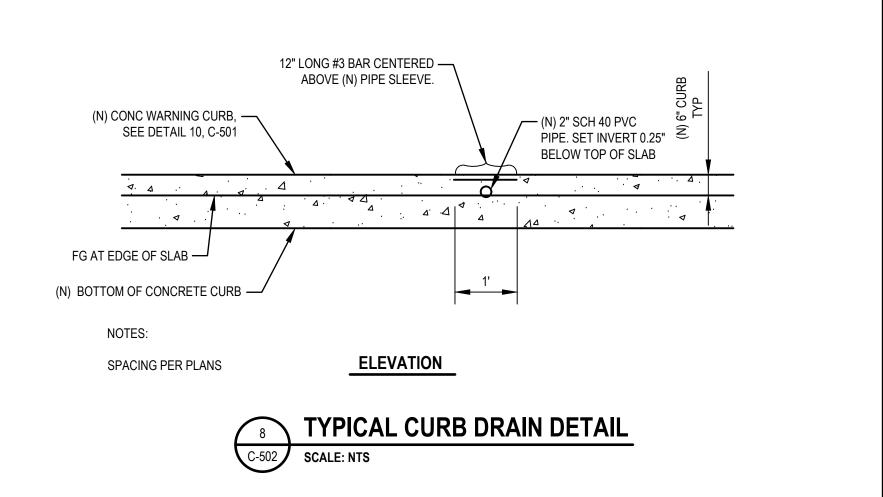

INMMO: (J tBP project number: 22079.00 file name: 12609766-C-501_CIVIL DETAILS drawn by: CSC / CP checked by: MD date: 12/5/2023 rev: date: description: 12/6/2023 BID SET

CIVIL DETAILS 2
SCALE: AS SHOWN

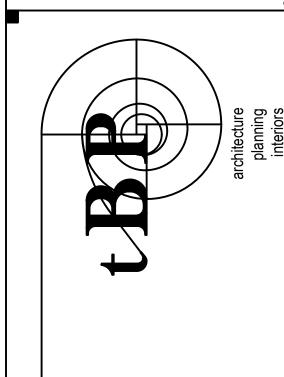

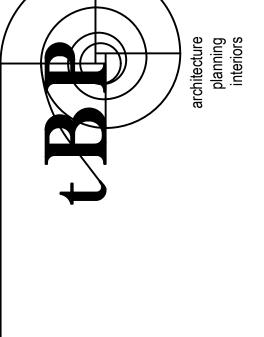










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CIVIL DETAILS 2

C-502

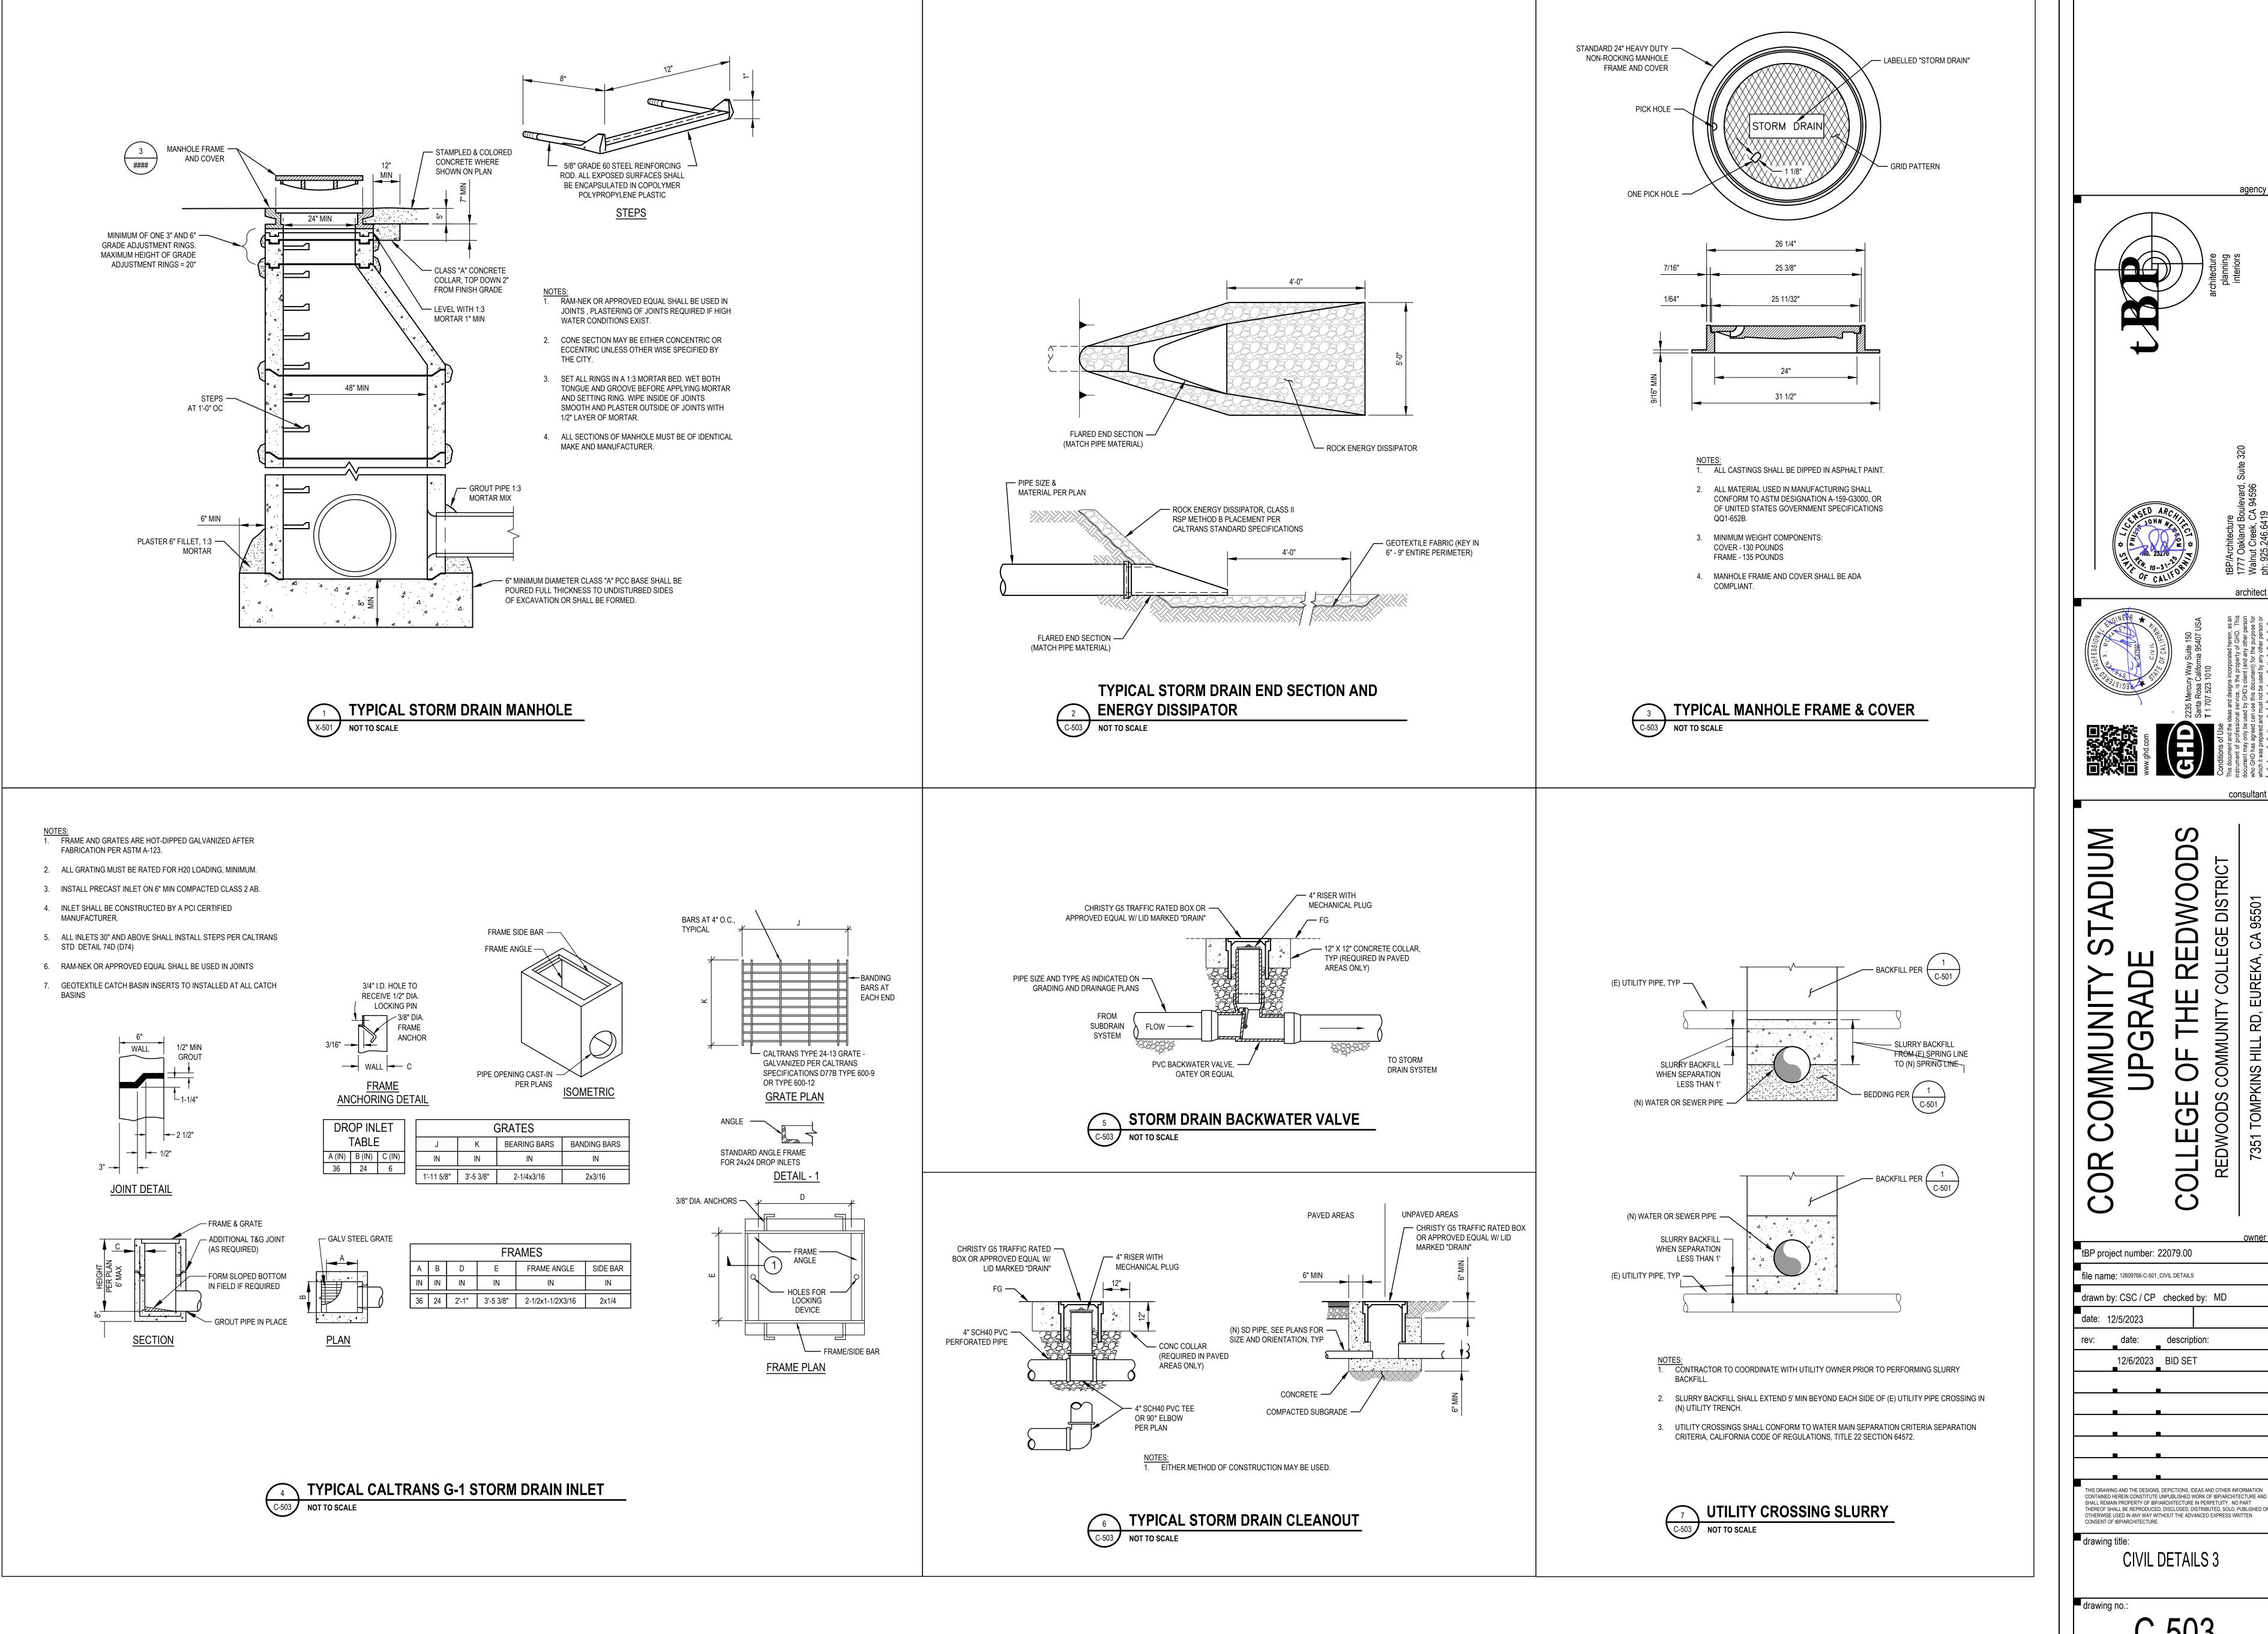

CIVIL DETAILS 3
SCALE: AS SHOWN


C-503

CIVIL DETAILS 3

_12/6/2023 _ BID SET

GR GR

agency

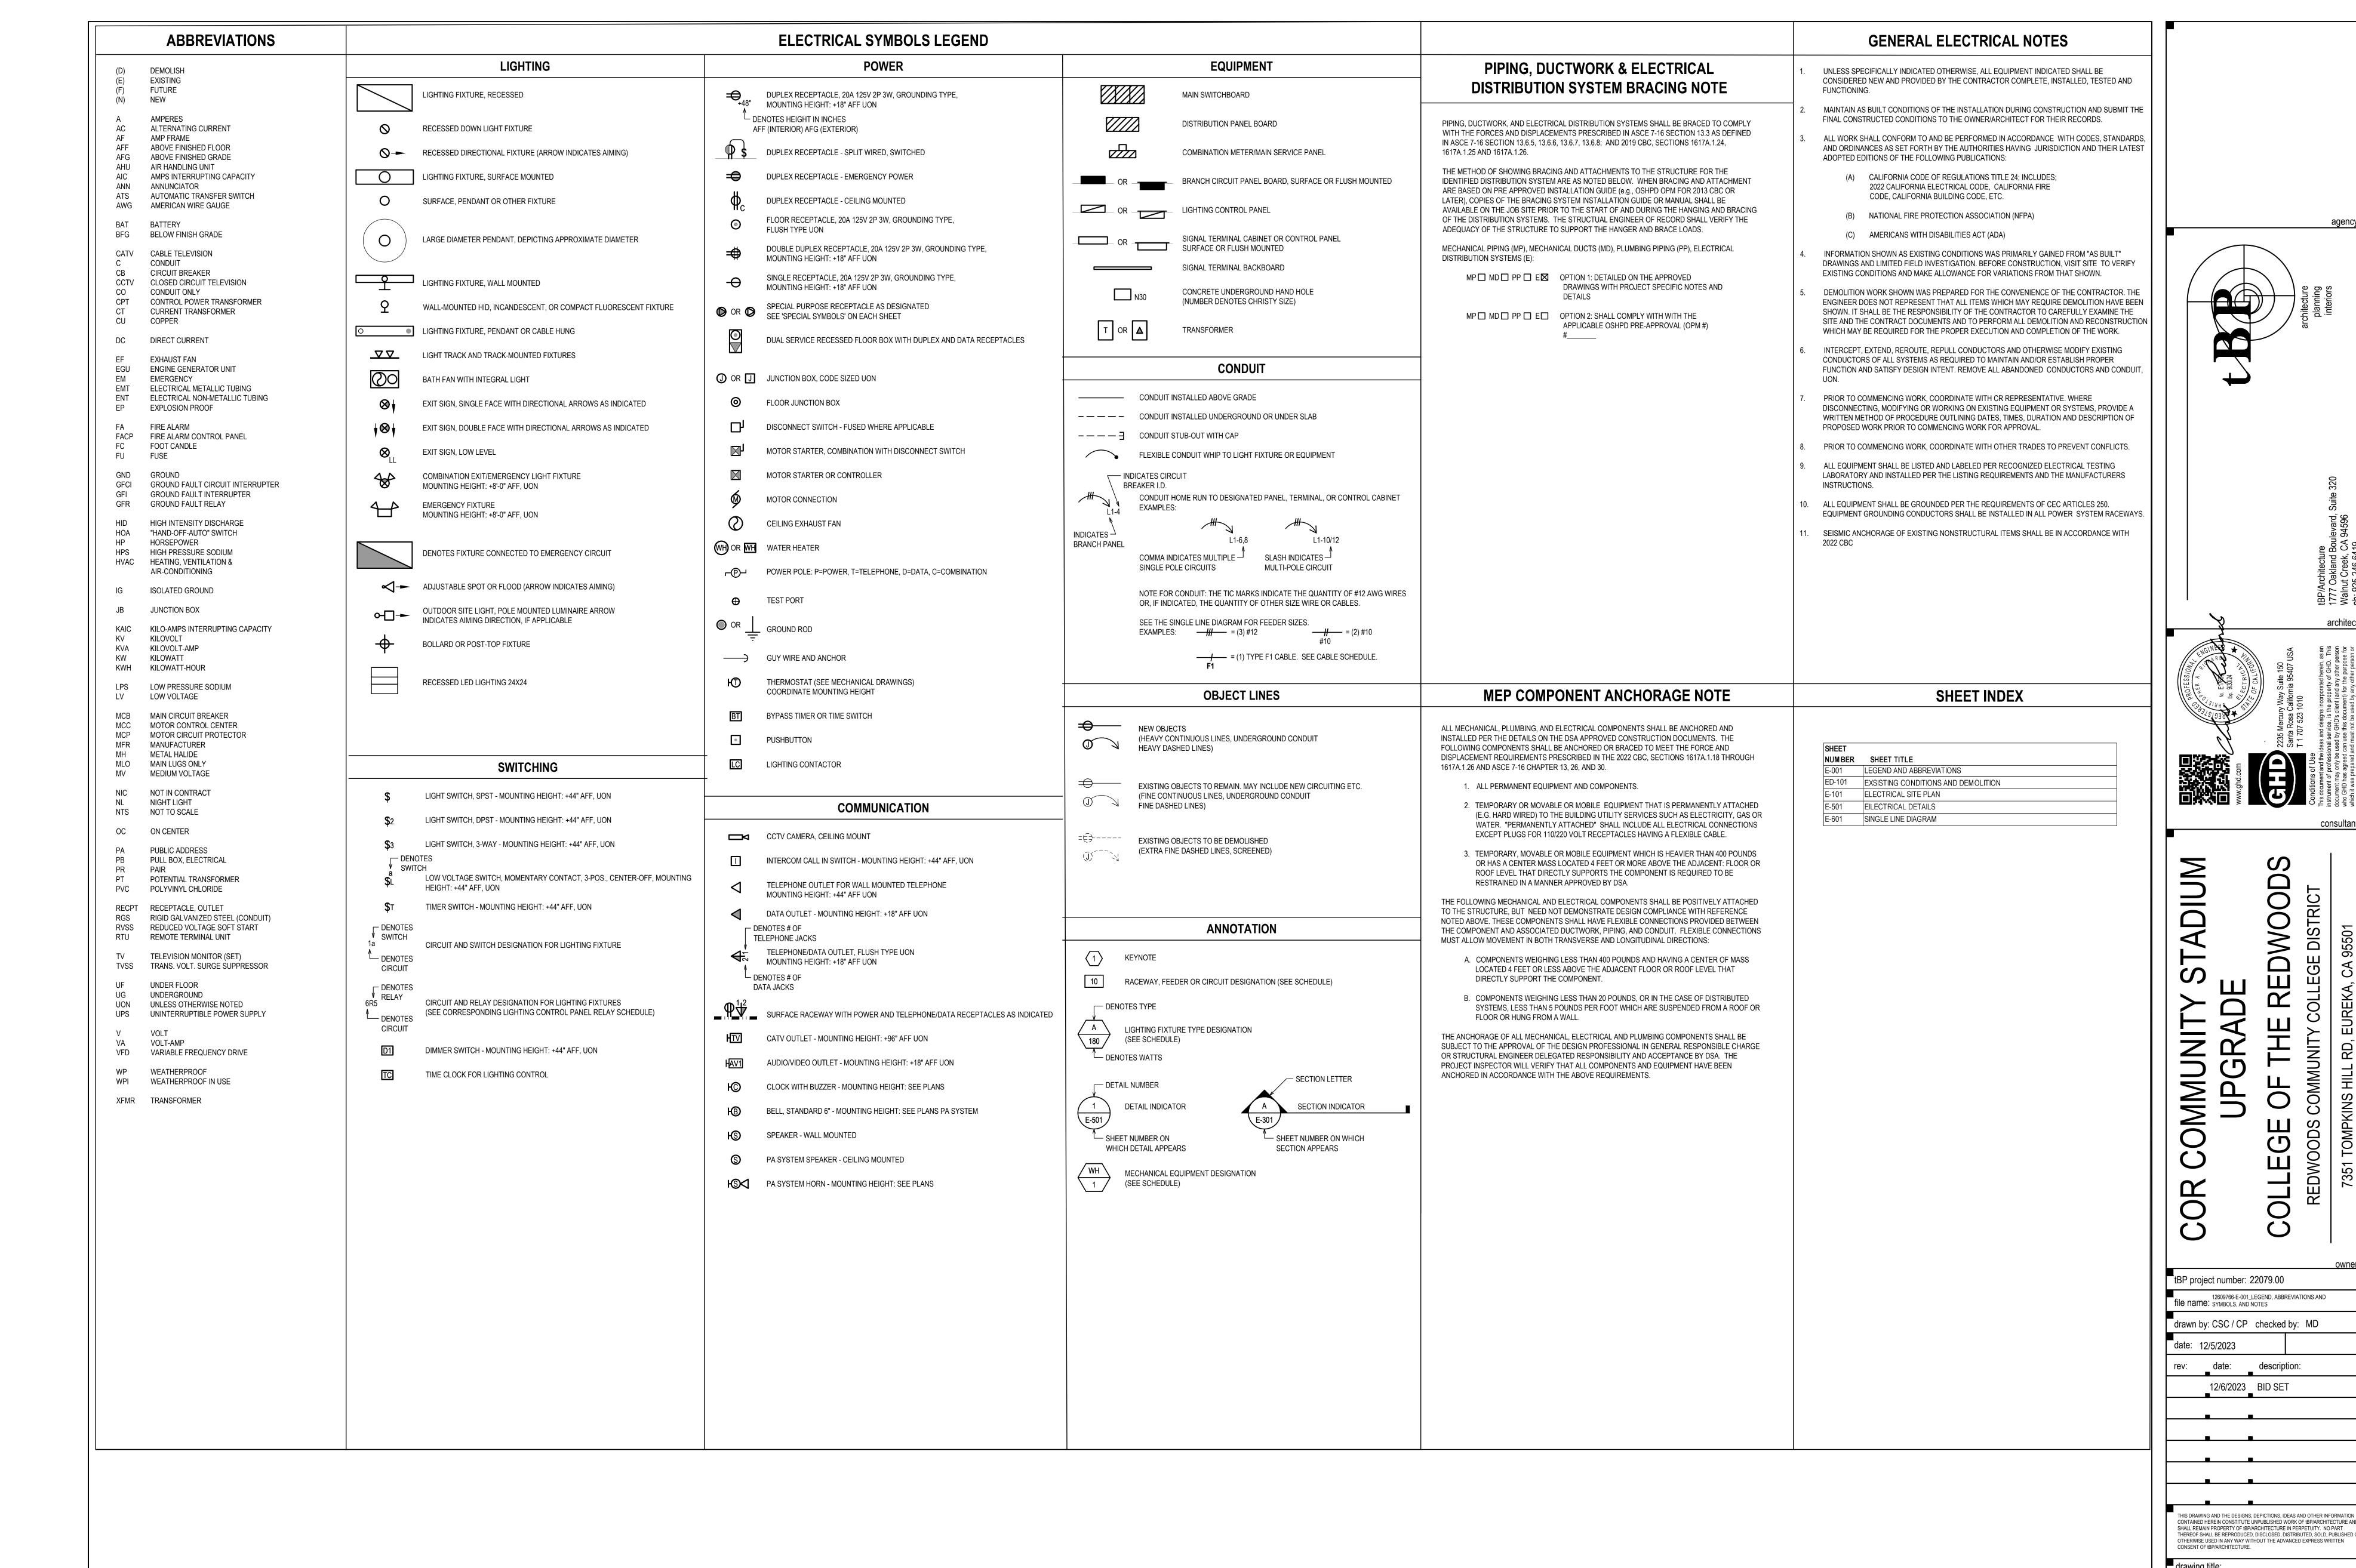


LEGEND, ABBREVIATIONS AND


SYMBOLS, AND NOTES


E-001

architect

EDWOODS

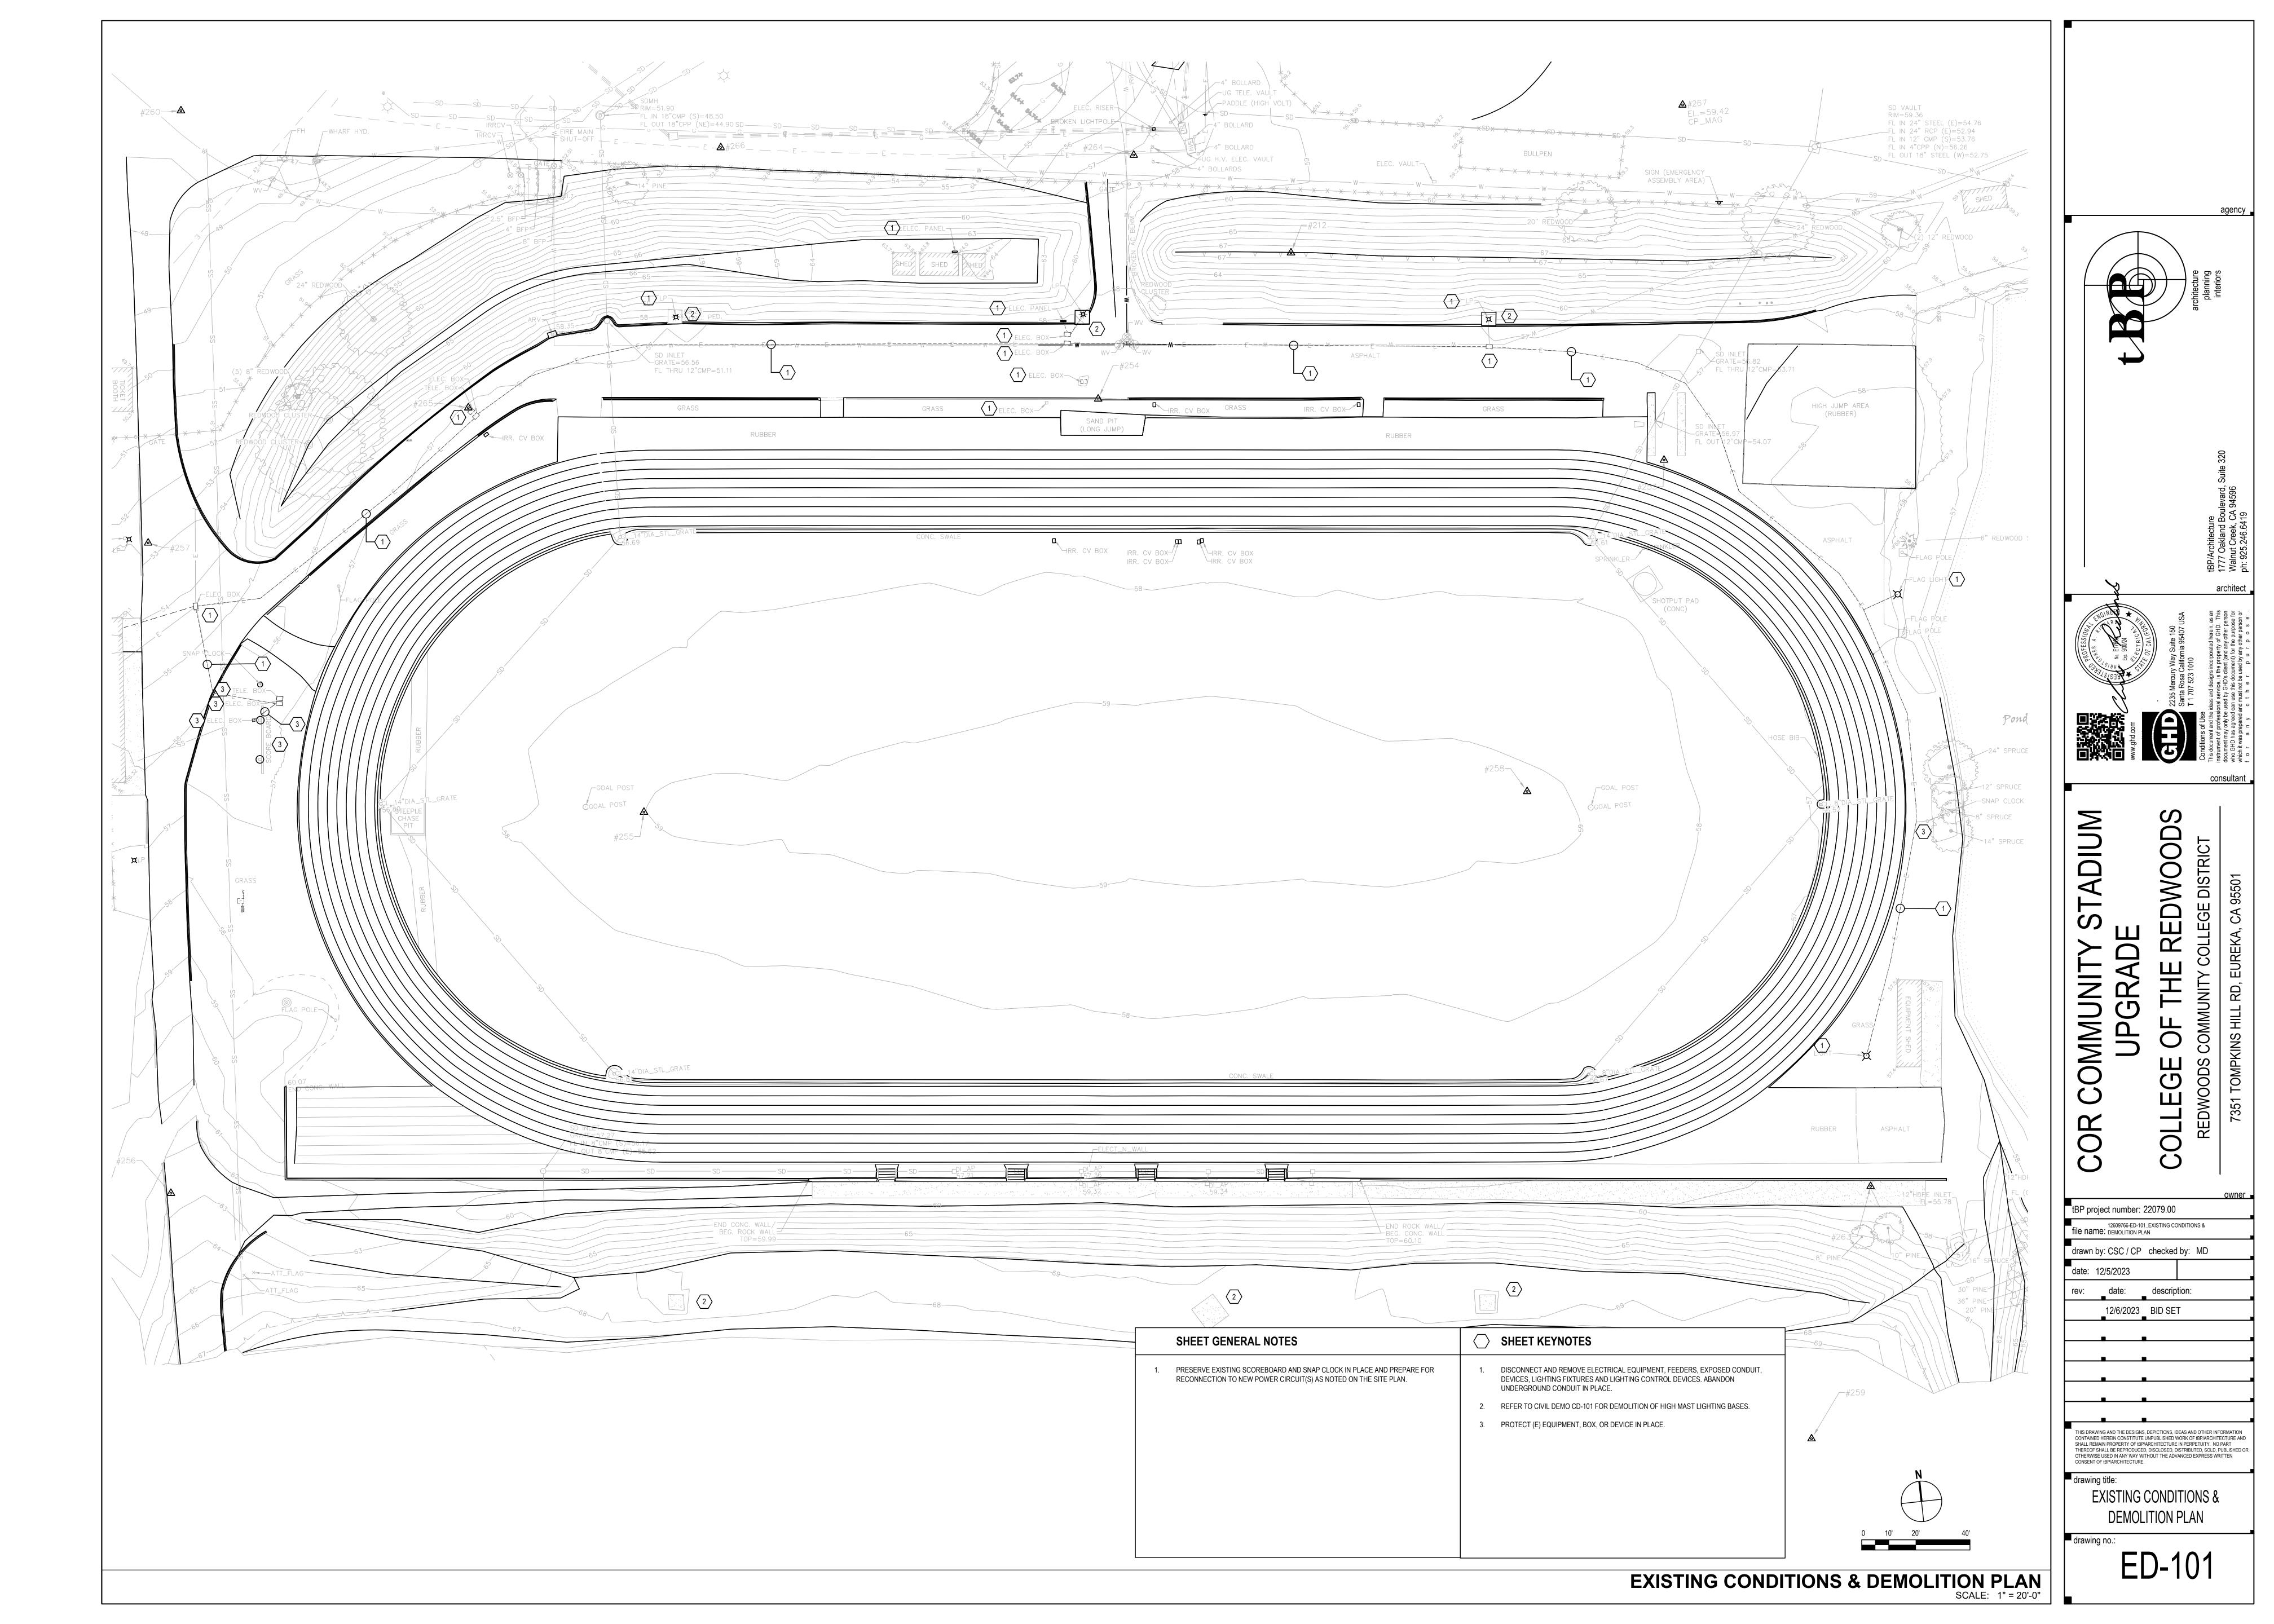

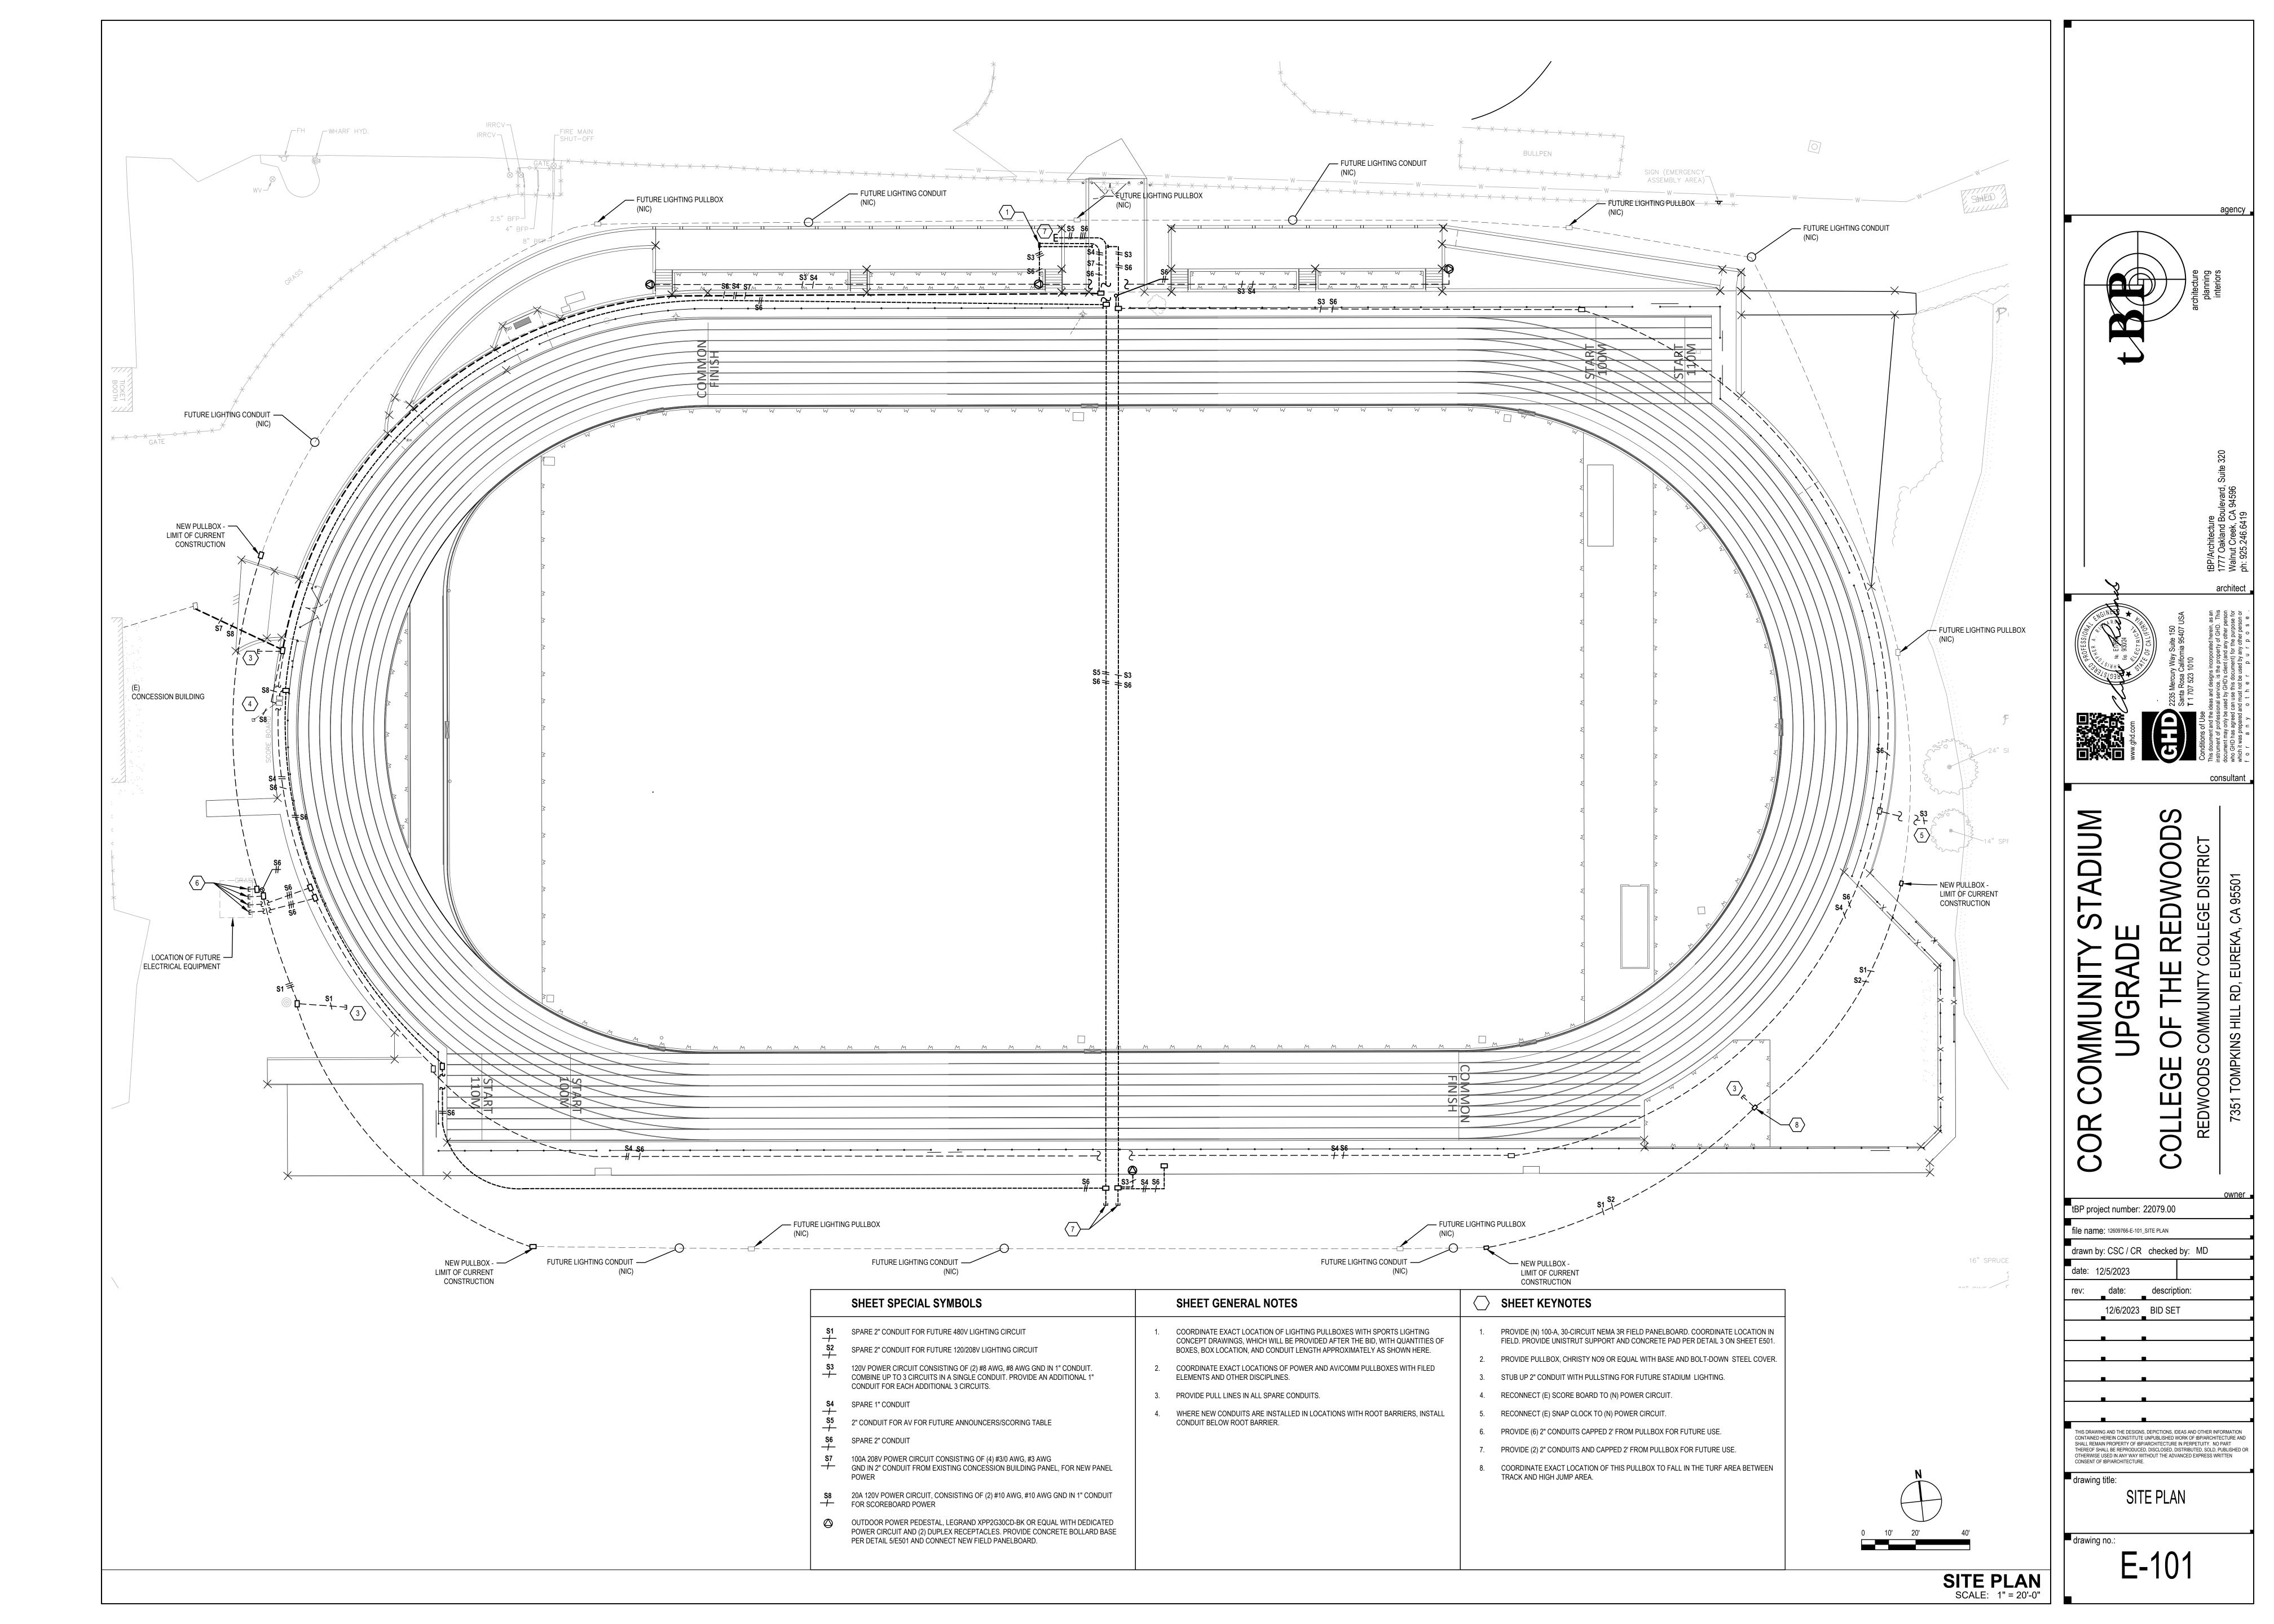

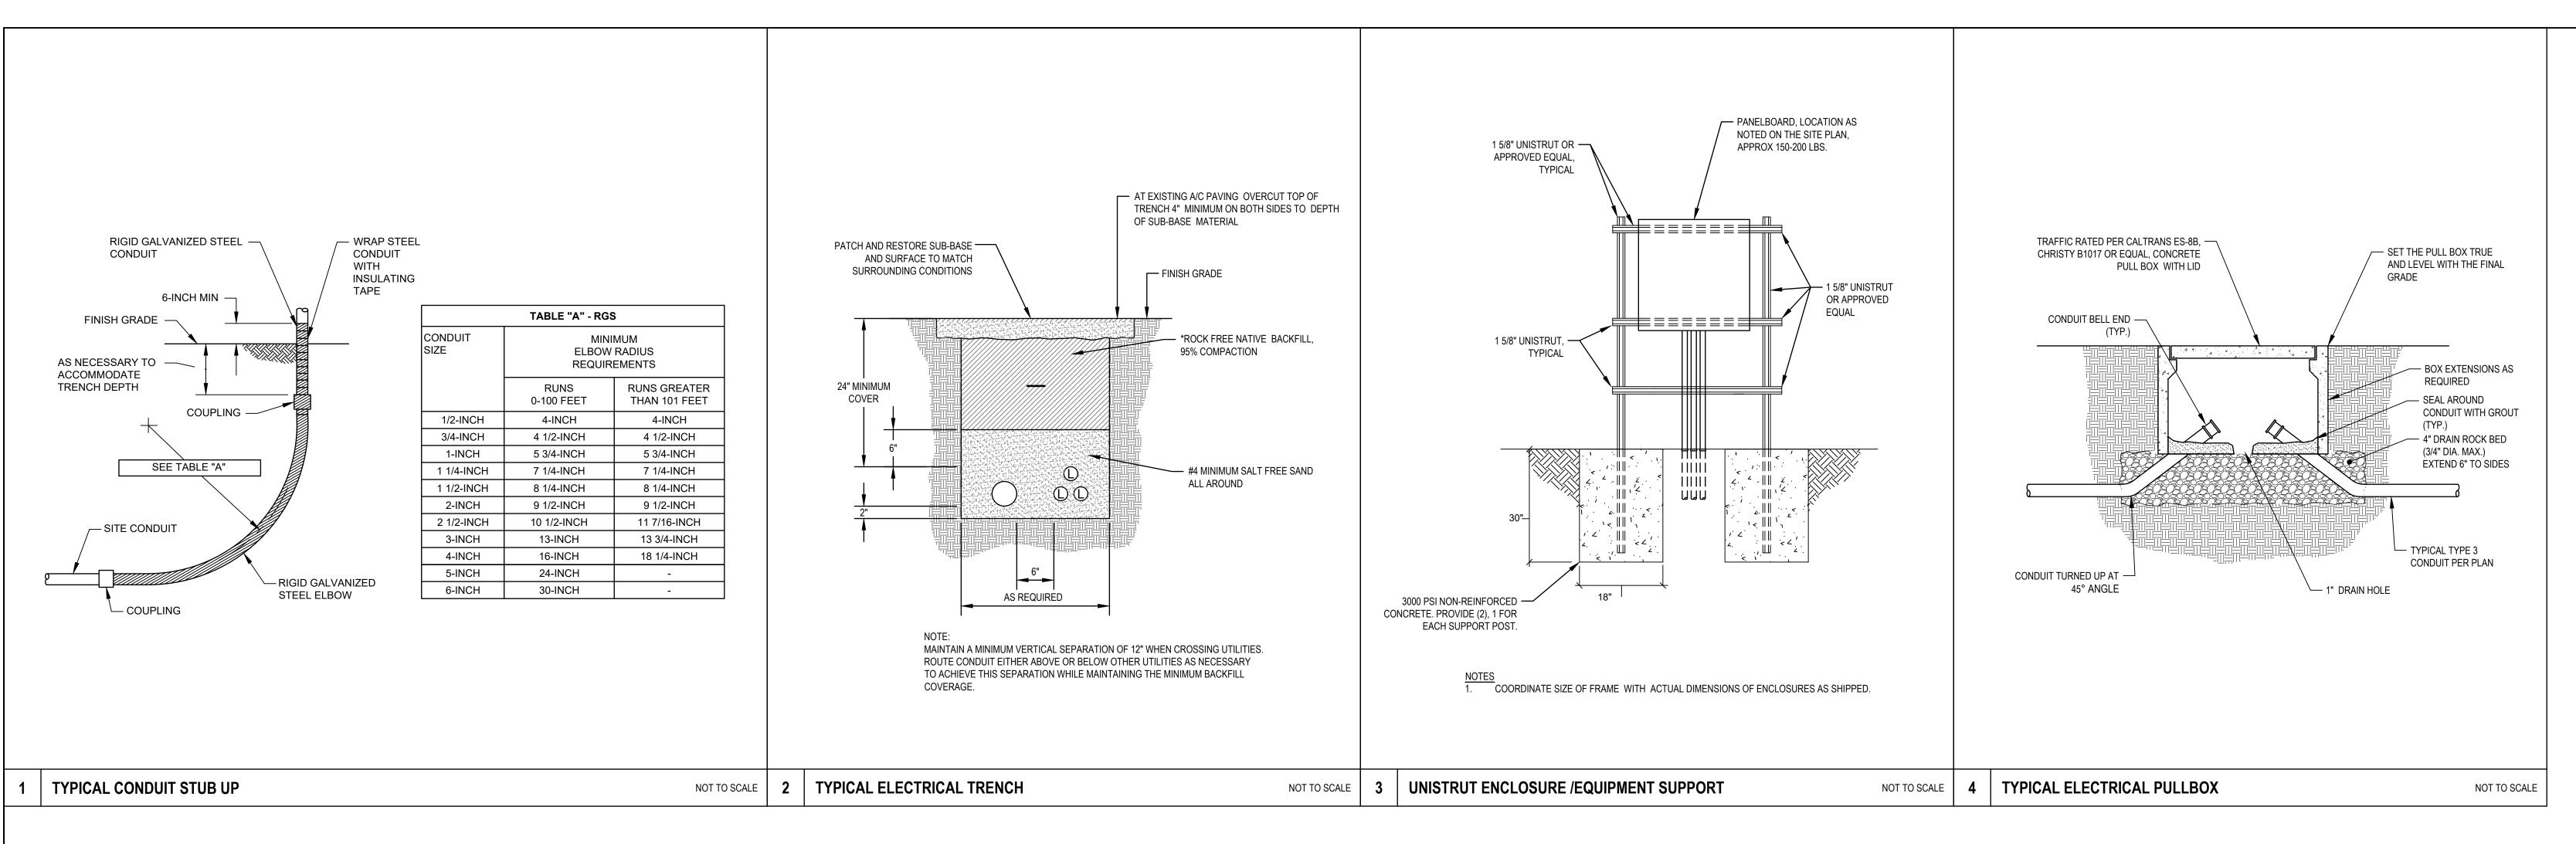



REDWOODS file name: 12609766-E-601_SINGLE LINE DIAGRAM drawn by: CSC / CP checked by: MD date: 12/5/2023 rev: date: description: 12/6/2023 BID SET

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SINGLE LINE DIAGRAM


E-601

UPGRADE COMMUNIT tBP project number: 22079.00


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	PROTESTION AND STATES A. P. L.	BELIEF AND ELIZER AND MANAGED AND AND AND AND AND AND AND AND AND AN	www.ghd.com	2235 Mercury Way Suite 150 Santa Rosa California 95407 USA T 1 707 523 1010			document may only be used by GHD's client (and any other person
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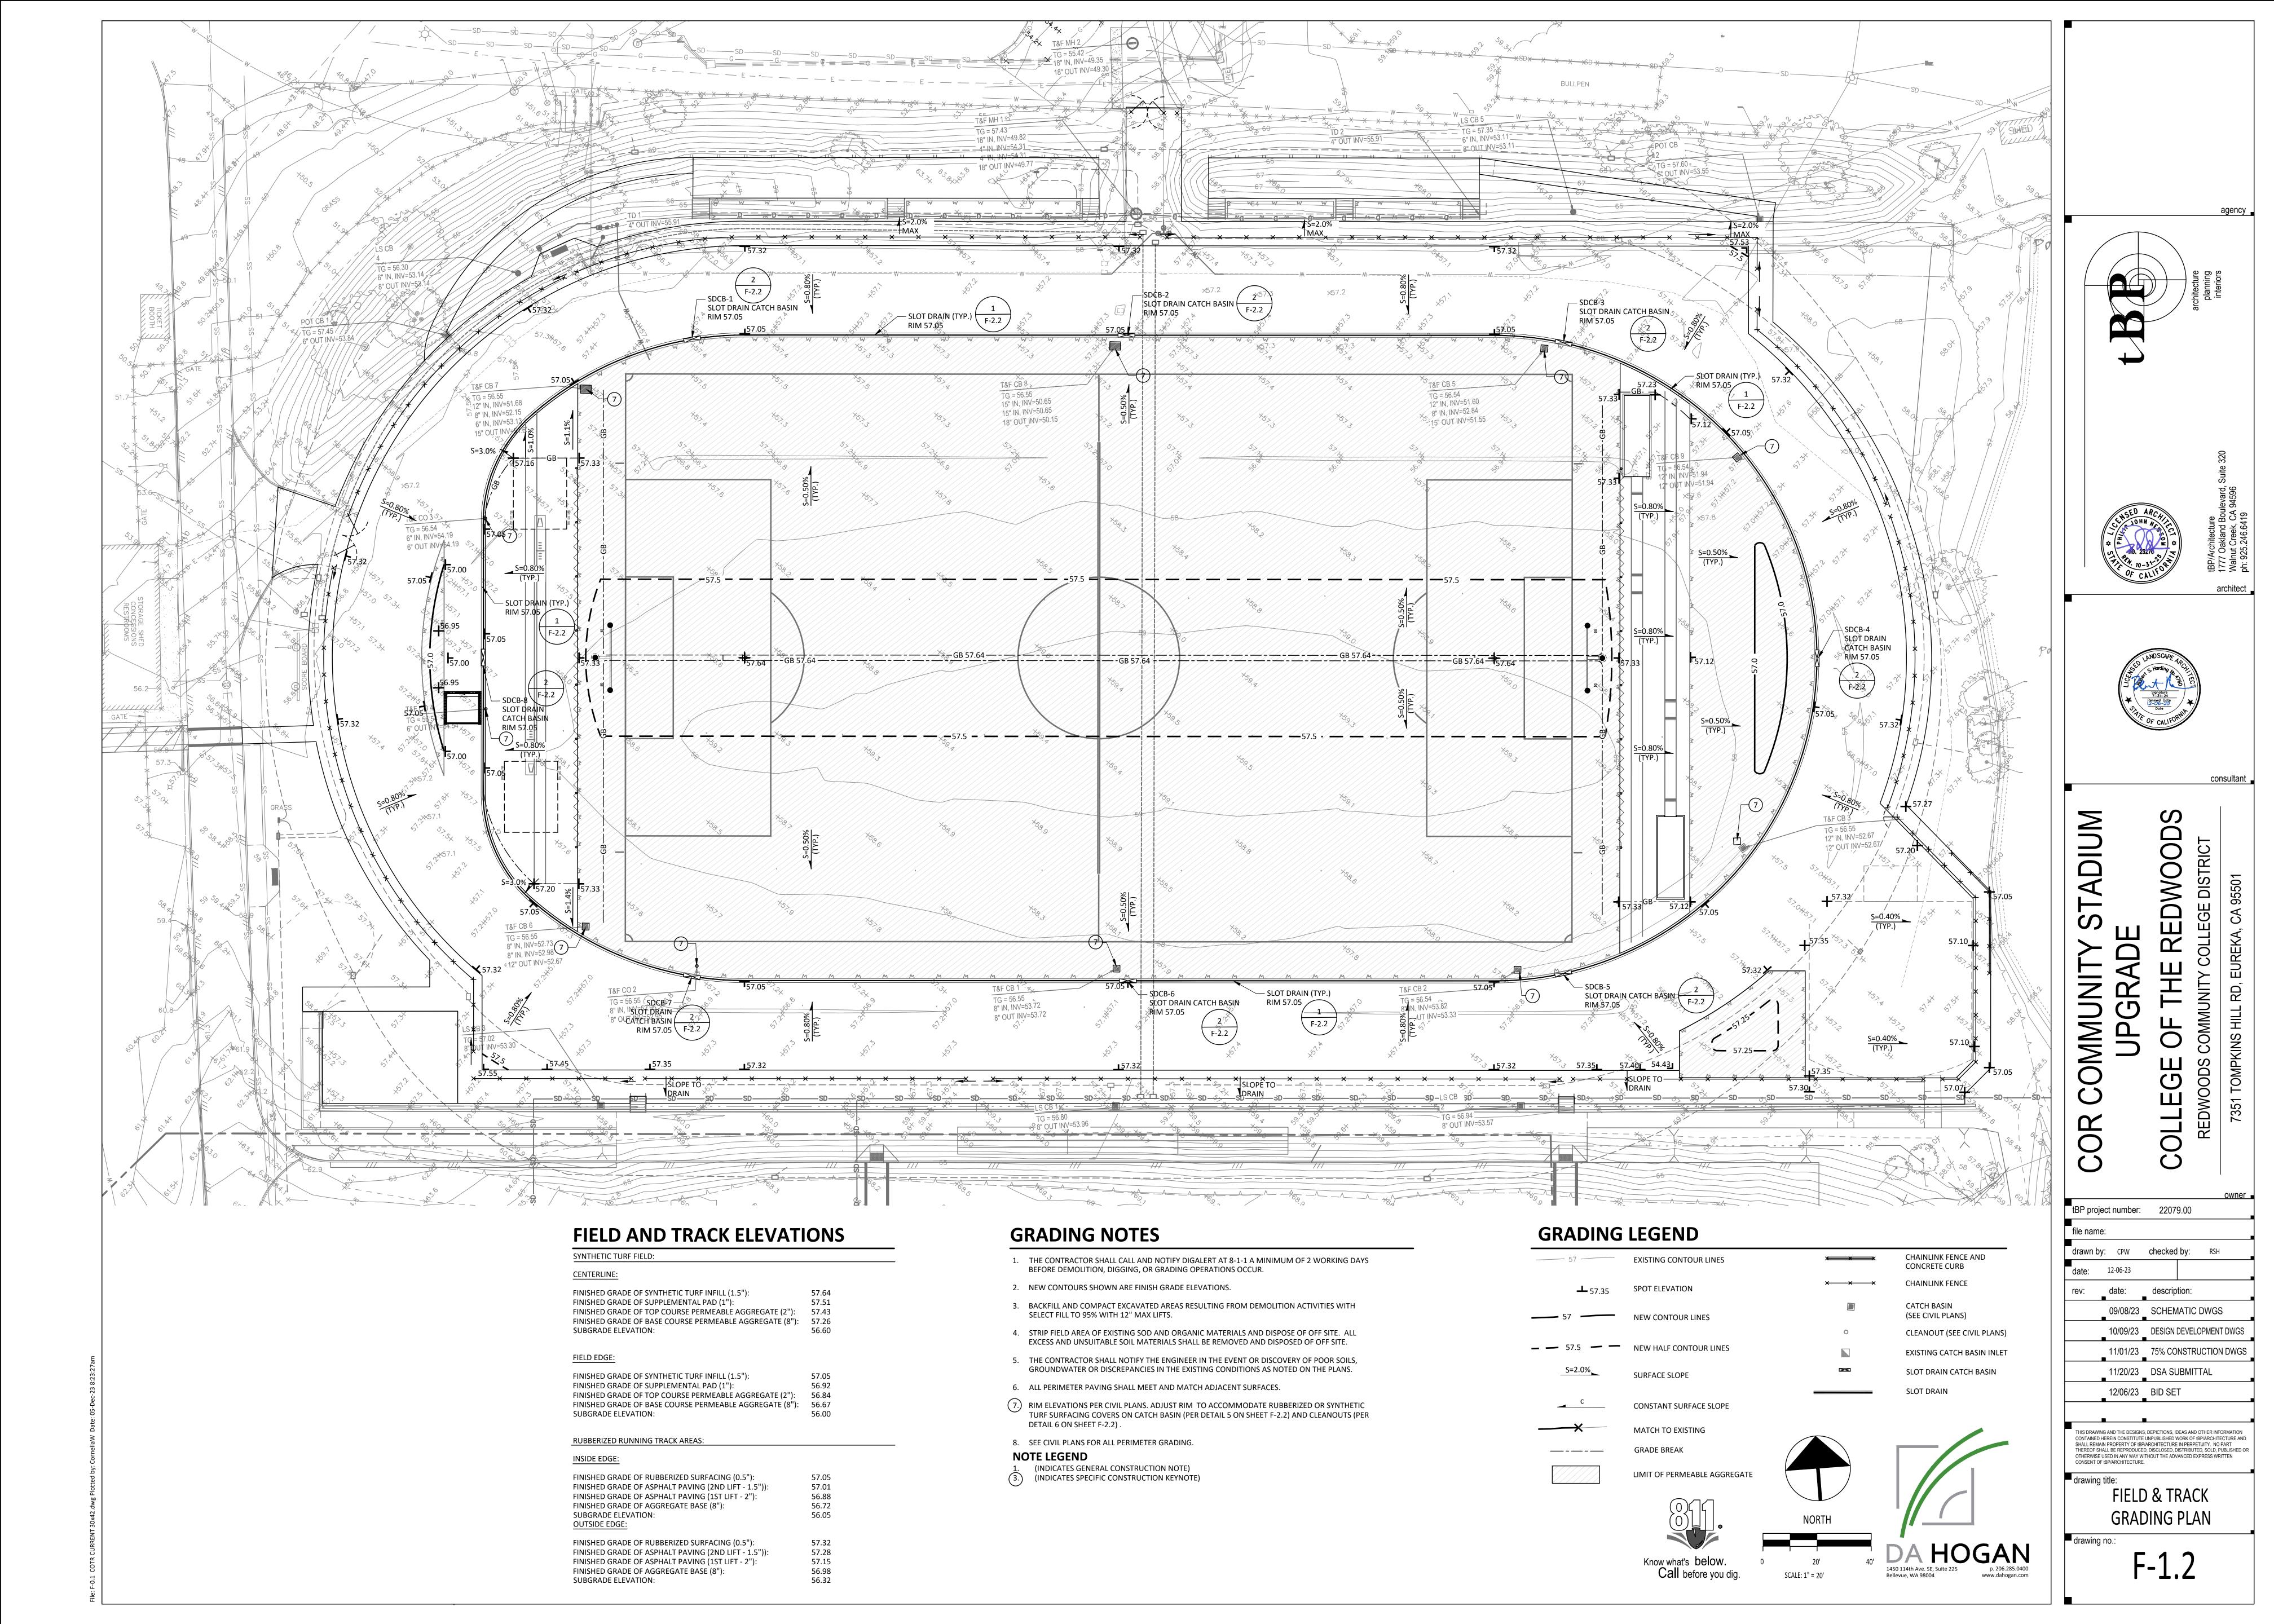
CONCESSION (E) SCOREBOARD FEEDER ROUTE (N) CIRCUIT IN (E) CONDUIT -SCOREBOARD *SEE SITE PLAN FOR FEEDER DESCRIPTIONS


2 PHASE 1 SINGLE LINE




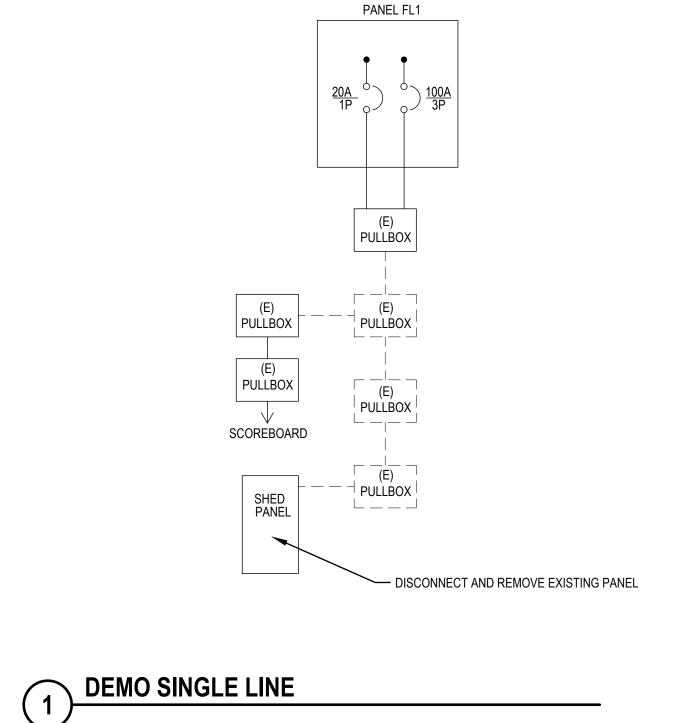




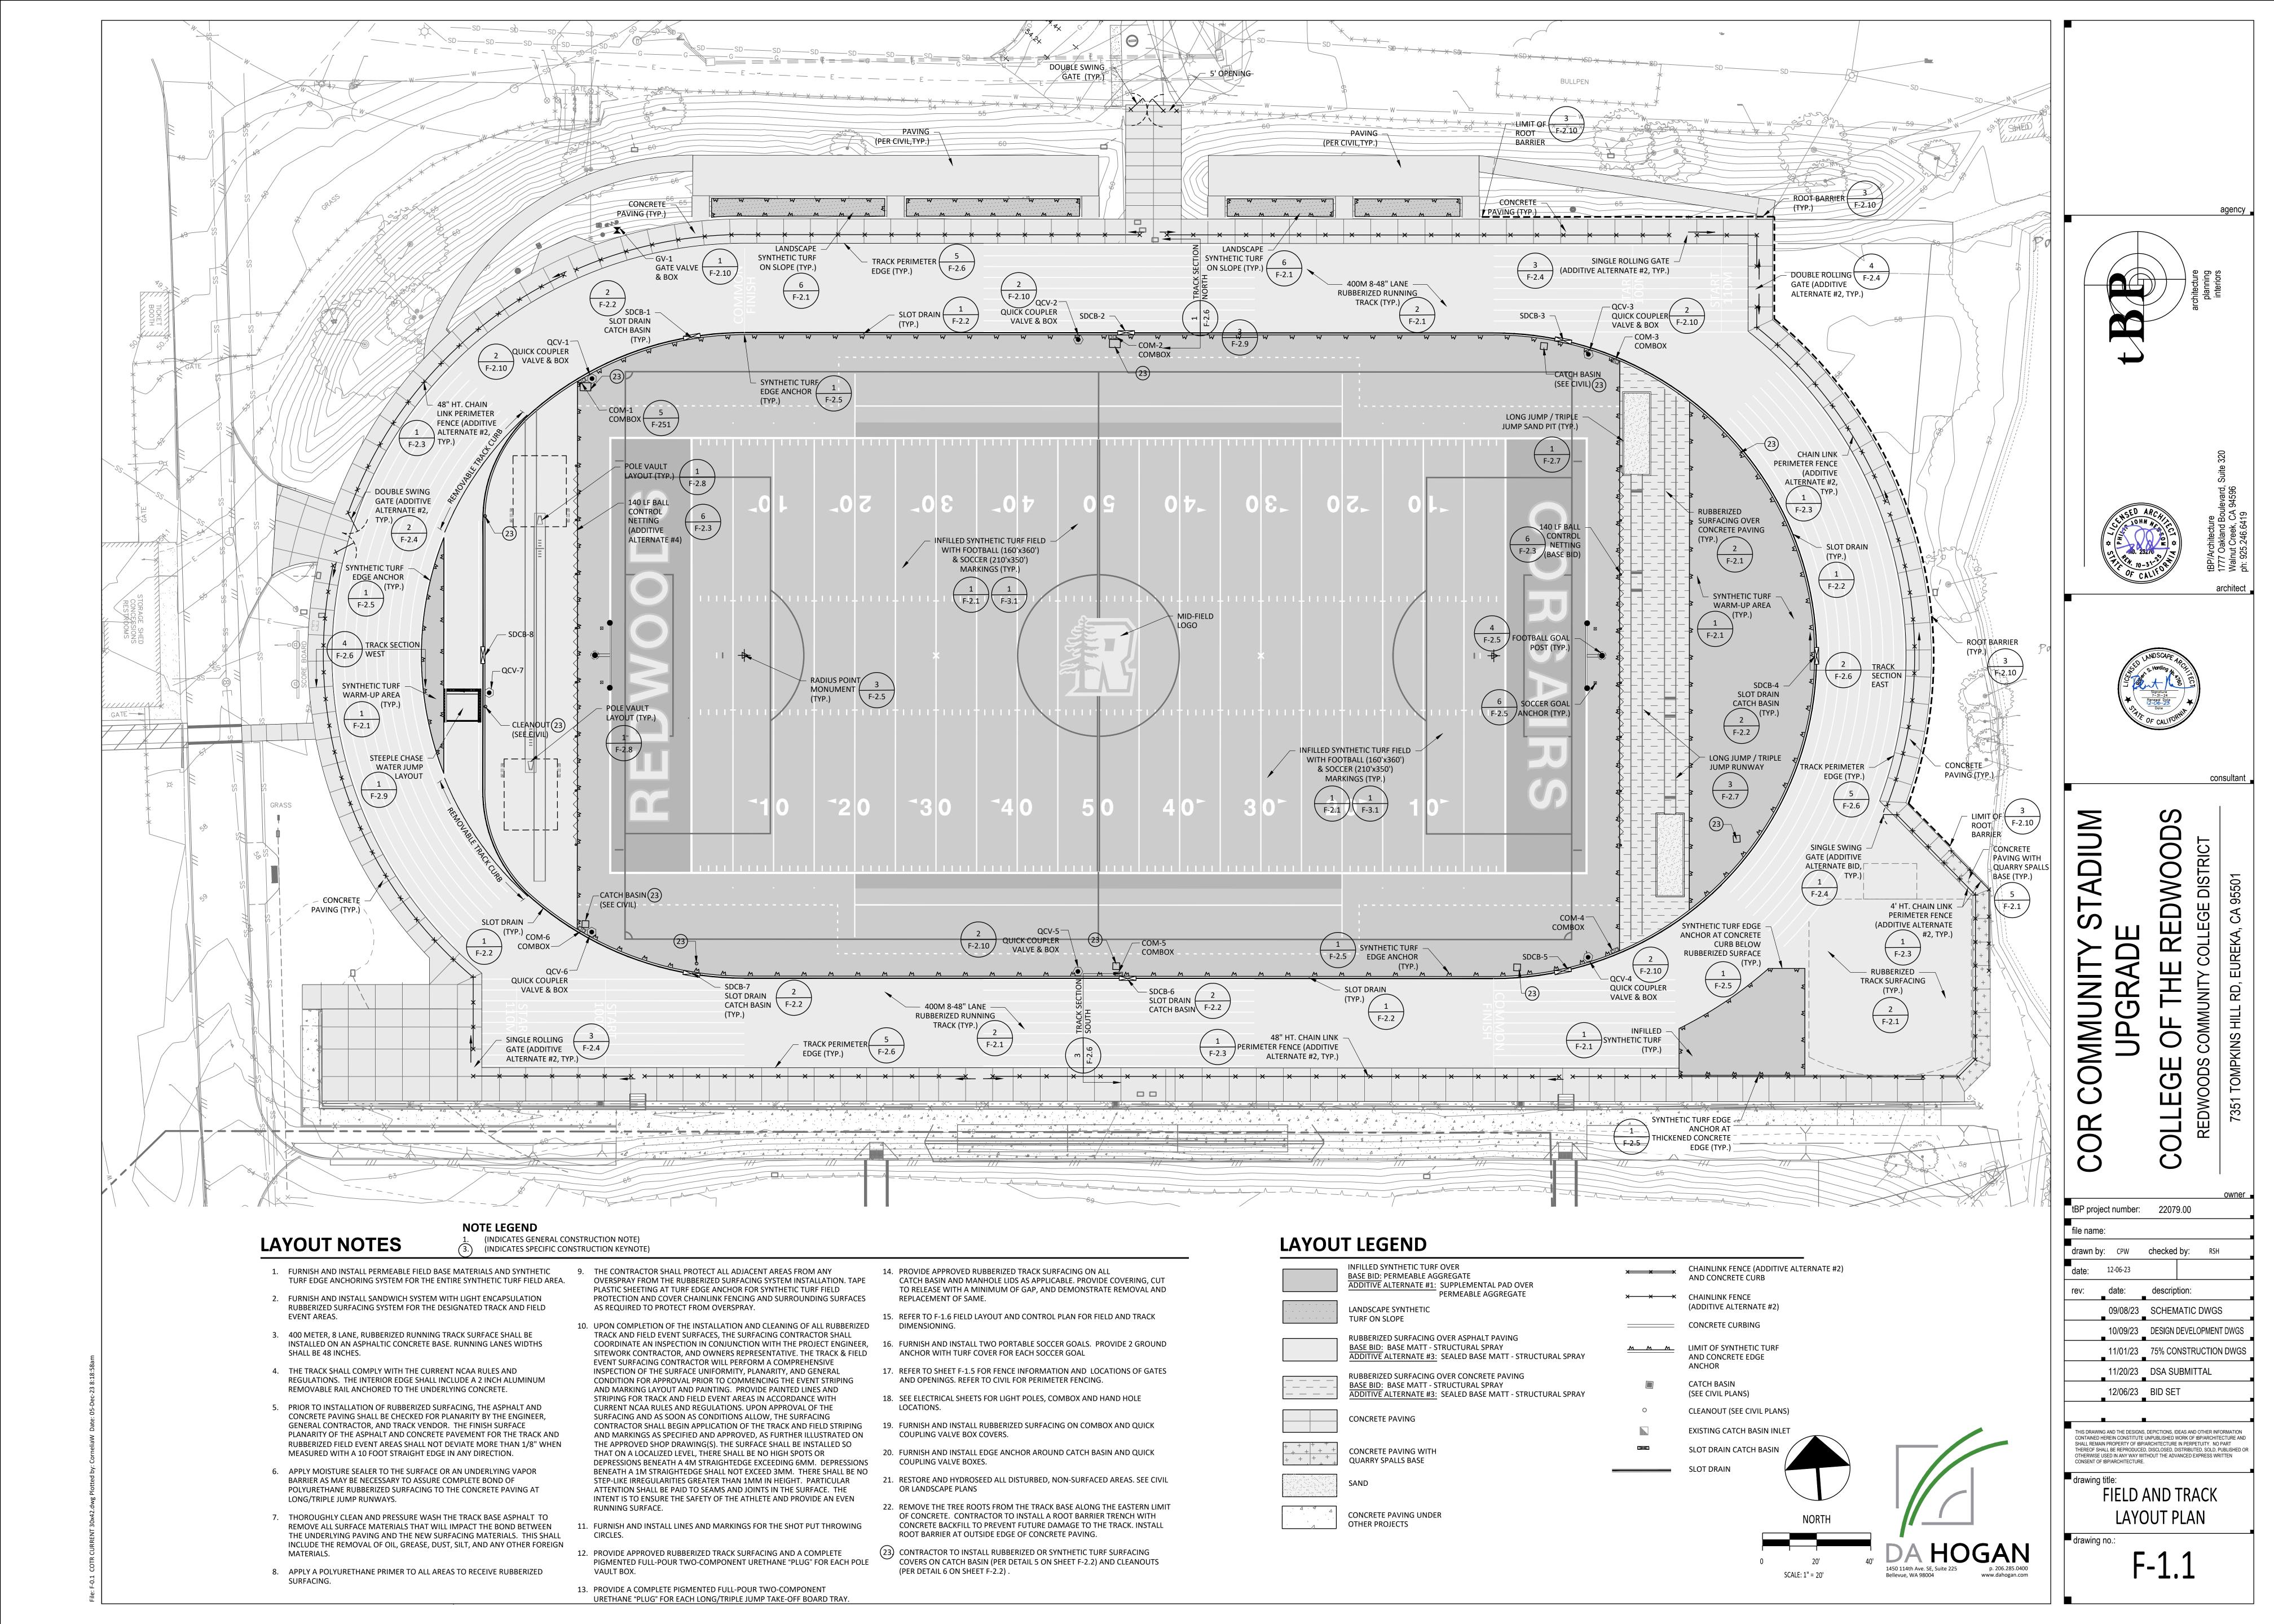

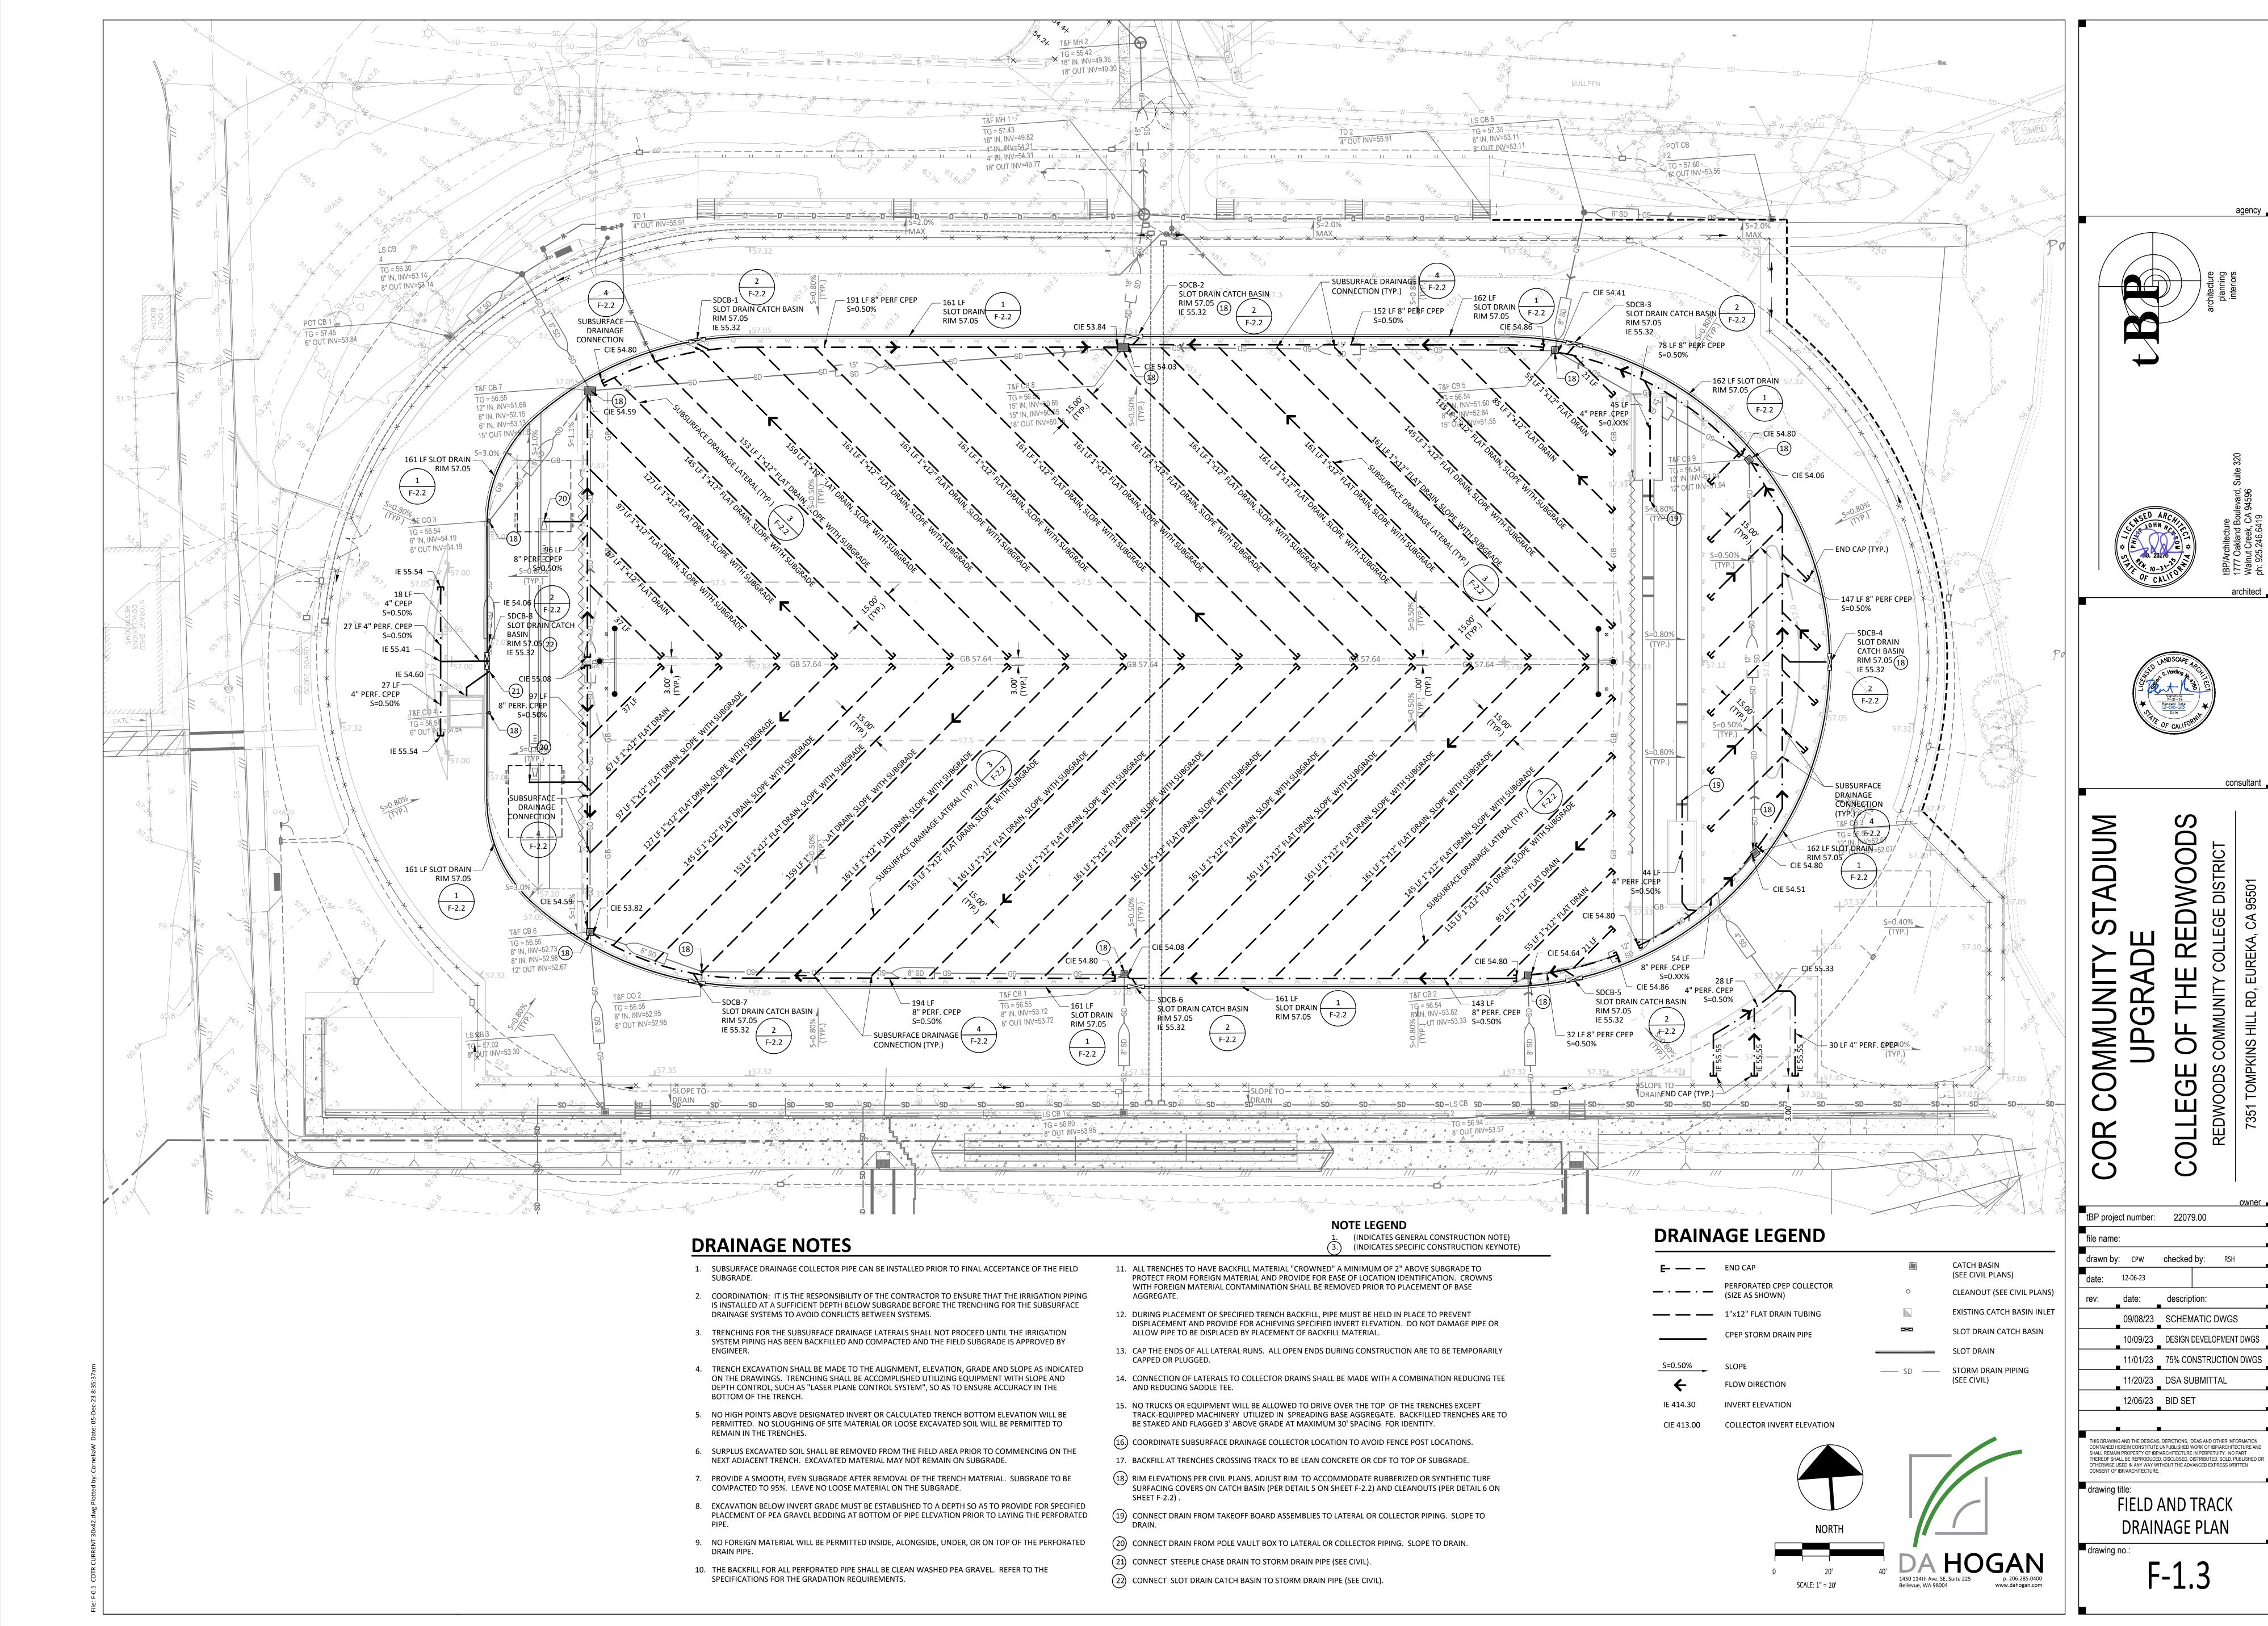

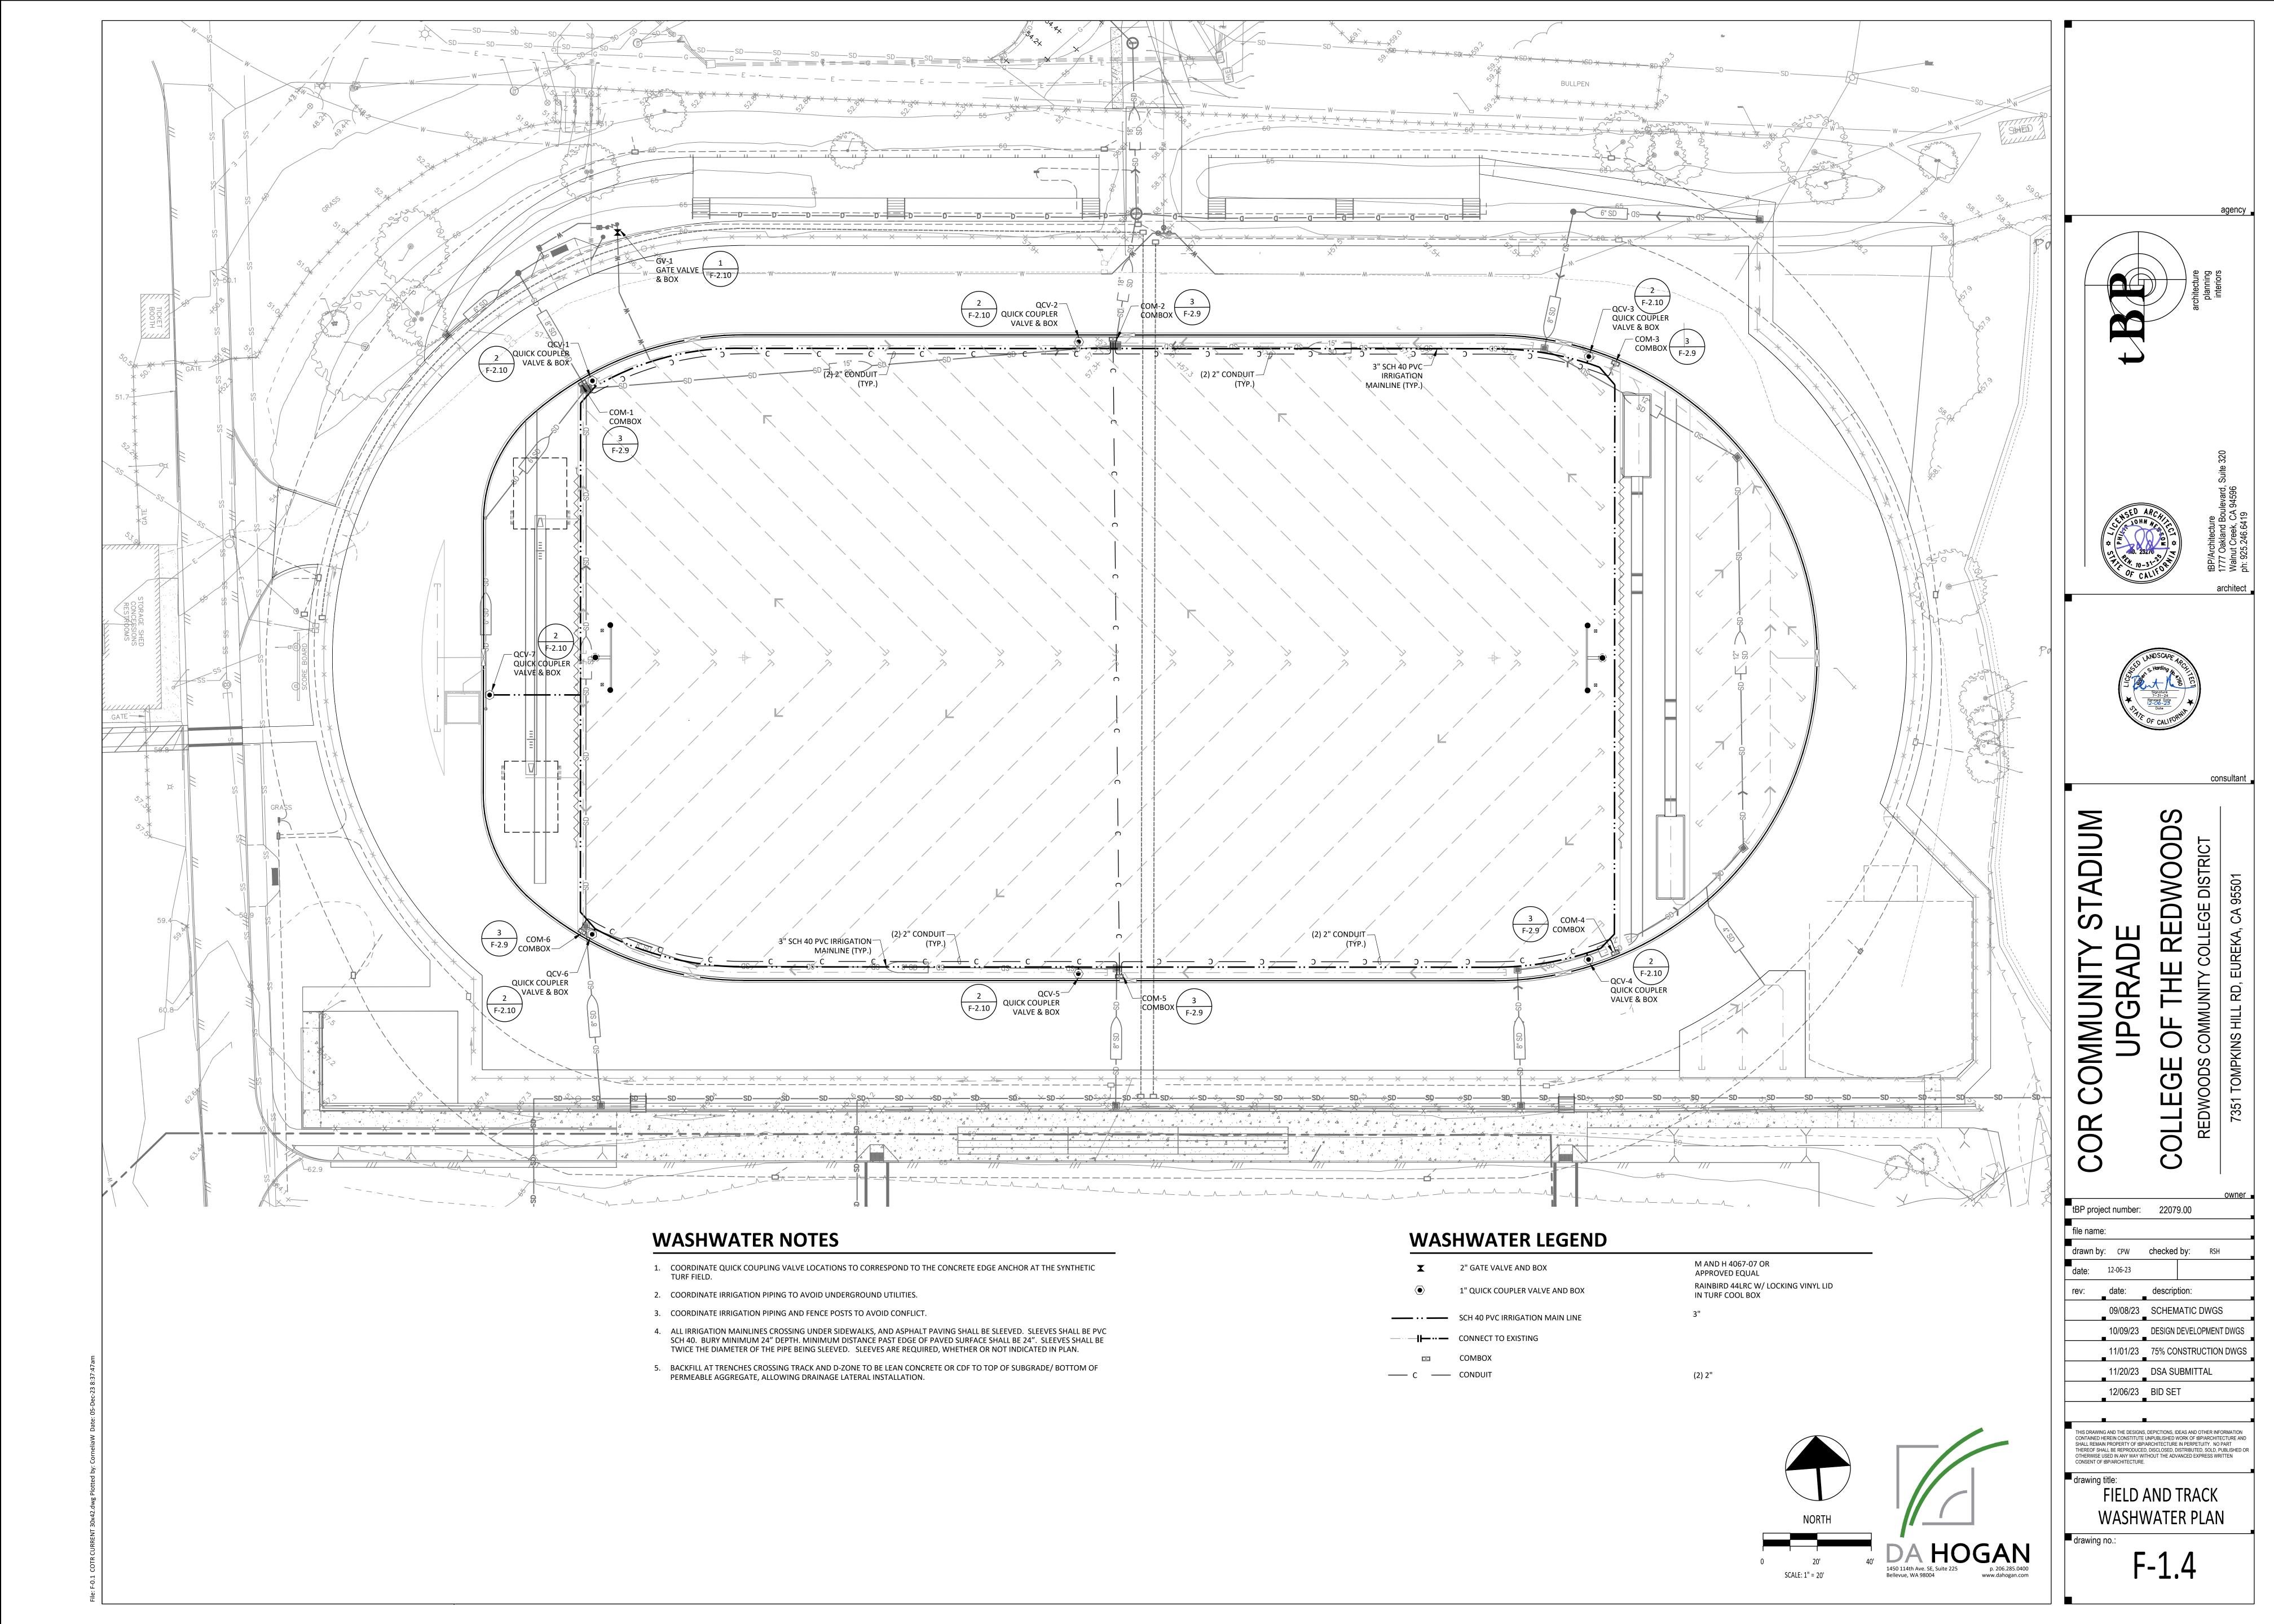

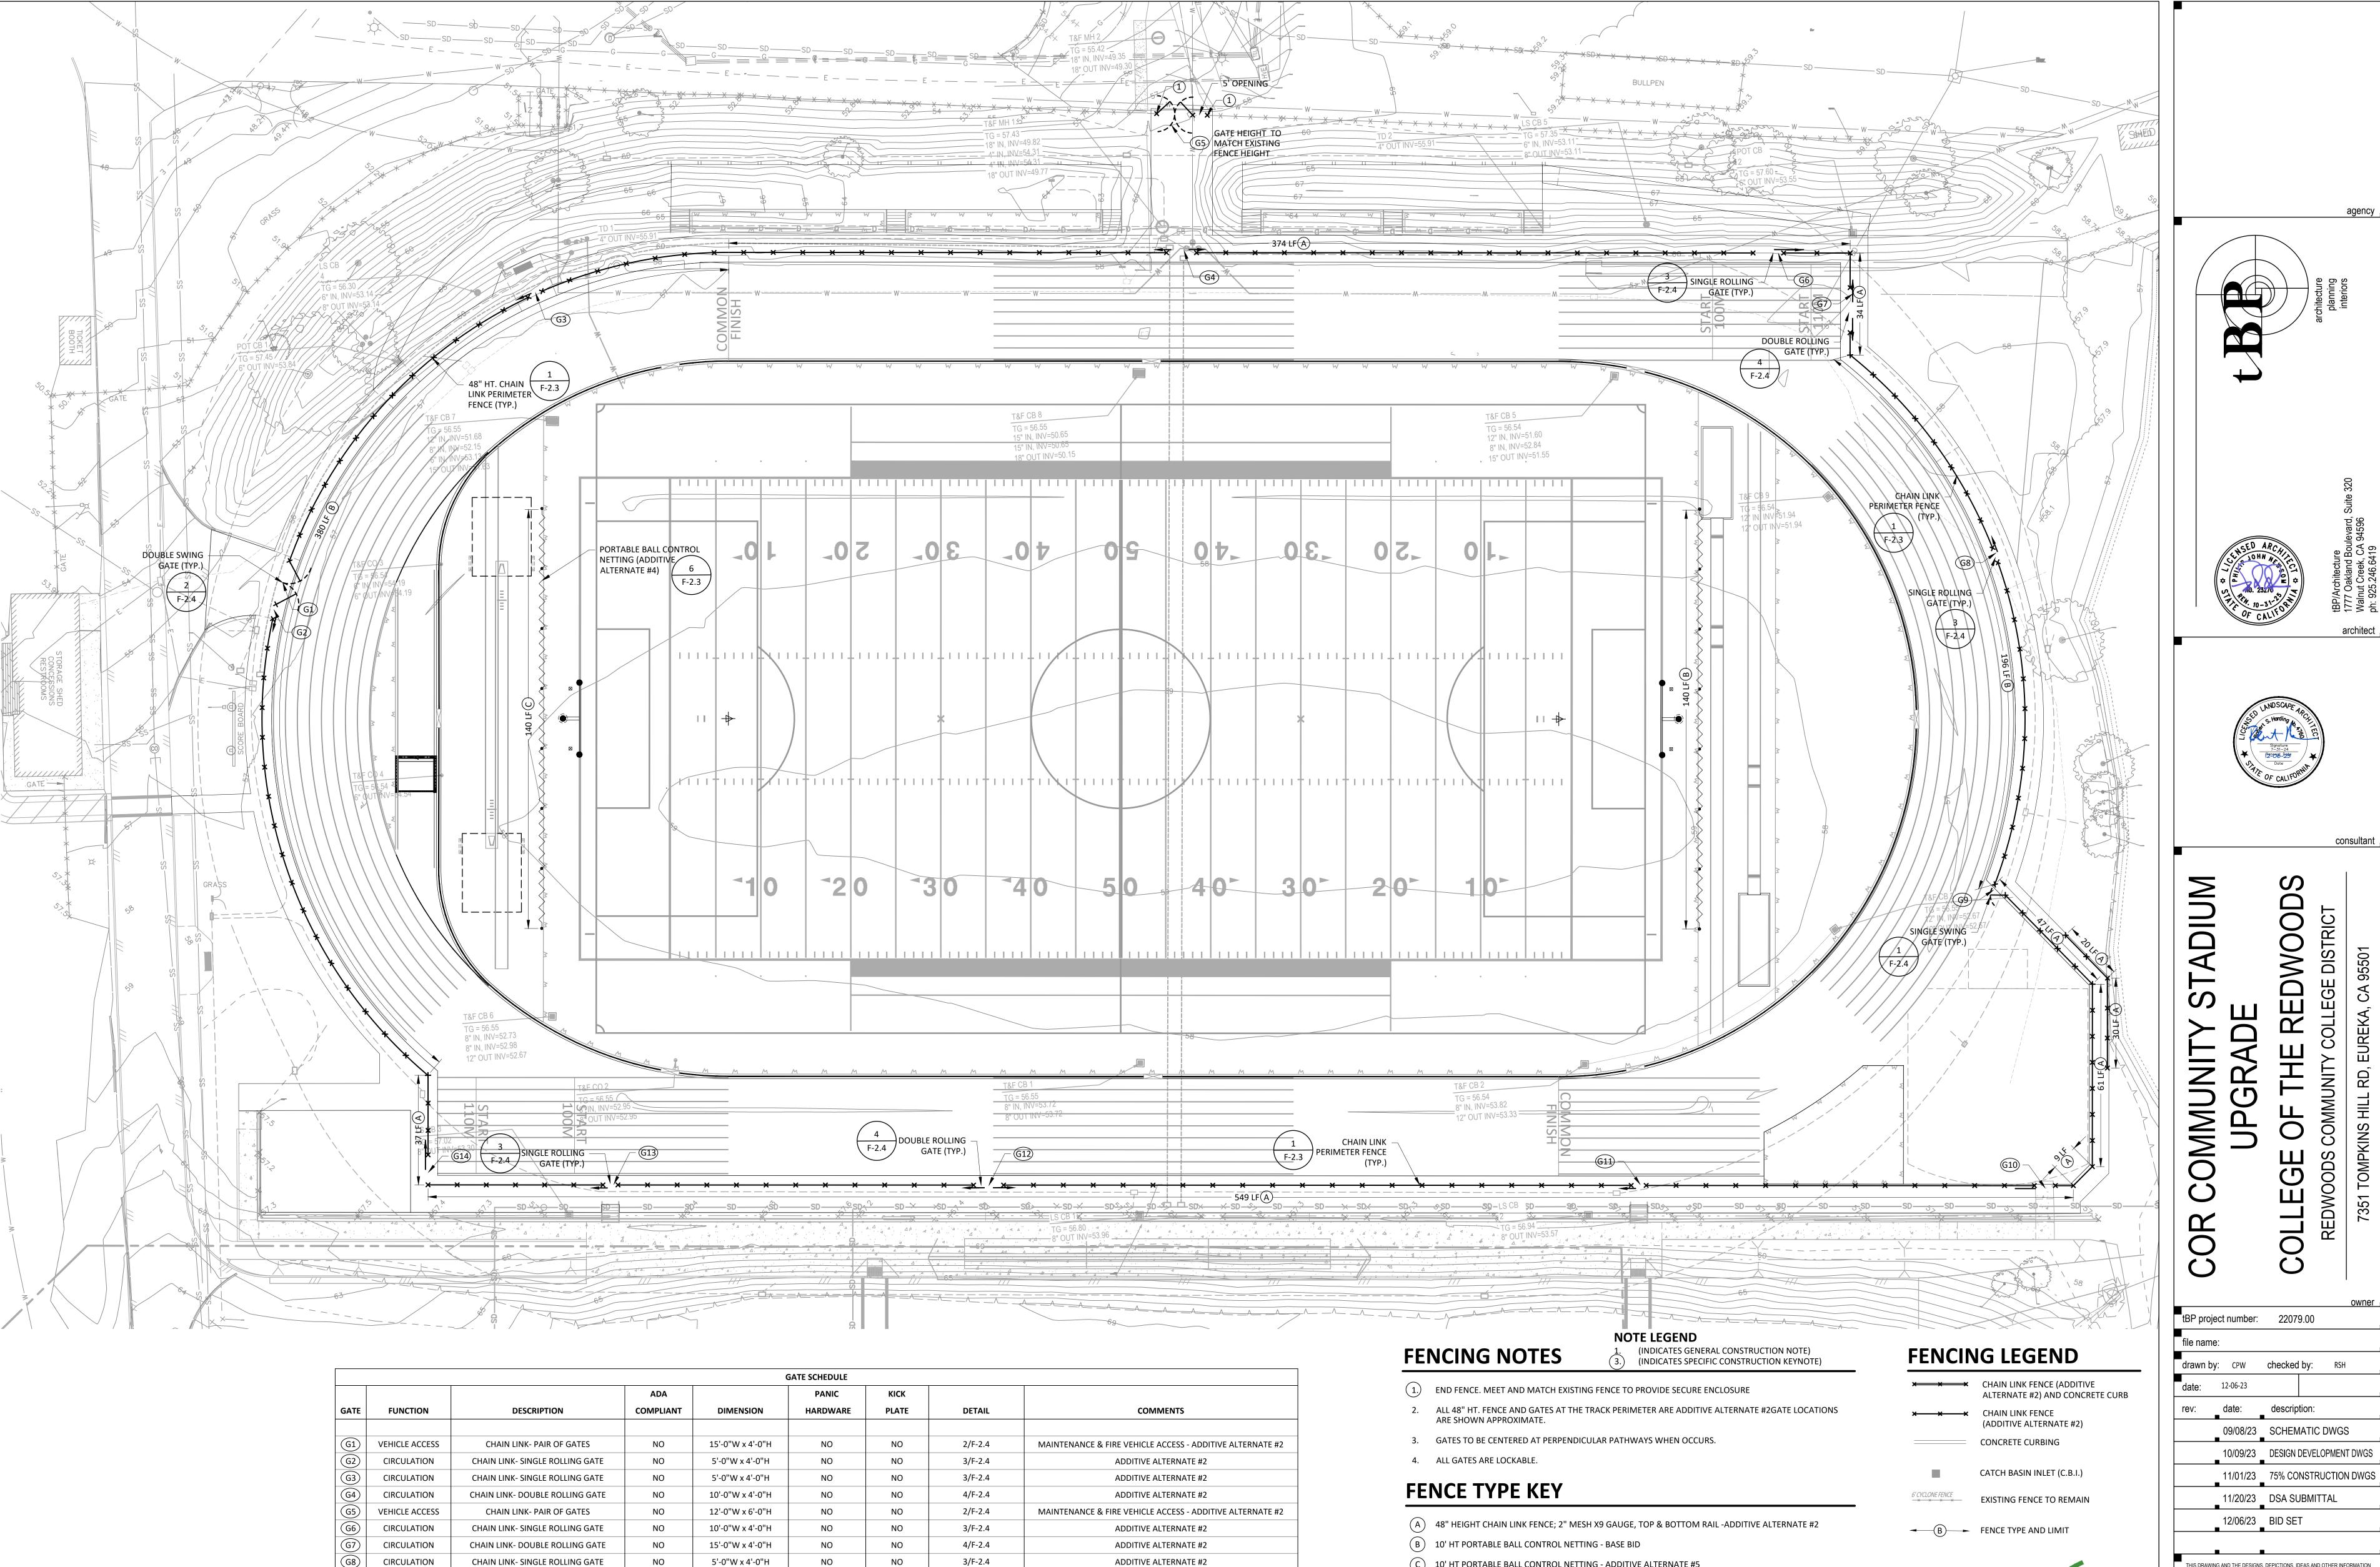

EGRESS

CIRCULATION

CIRCULATION

CIRCULATION

CIRCULATION

CIRCULATION

CHAIN LINK- SINGLE GATE

CHAIN LINK- SINGLE ROLLING GATE

CHAIN LINK- SINGLE ROLLING GATE

CHAIN LINK- DOUBLE ROLLING GATE

CHAIN LINK- SINGLE ROLLING GATE

CHAIN LINK- SINGLE ROLLING GATE

5'-0"W x 4'-0"H

7'-0"W x 4'-0"H

5'-0"W x 4'-0"H

10'-0"W x 4'-0"H

5'-0"W x 4'-0"H

10'-0"W x 4'-0"H

YES

NO

NO

NO

NO

NO

1/F-2.4

3/F-2.4

3/F-2.4

4/F-2.4

3/F-2.4

3/F-2.4

ADDITIVE ALTERNATE #2

ADDITIVE ALTERNATE #2 ADDITIVE ALTERNATE #2

ADDITIVE ALTERNATE #2

ADDITIVE ALTERNATE #2

ADDITIVE ALTERNATE #2

C) 10' HT PORTABLE BALL CONTROL NETTING - ADDITIVE ALTERNATE #5




Bellevue, WA 98004

SCALE: 1" = 20'

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_ 09/08/23 _ SCHEMATIC DWGS

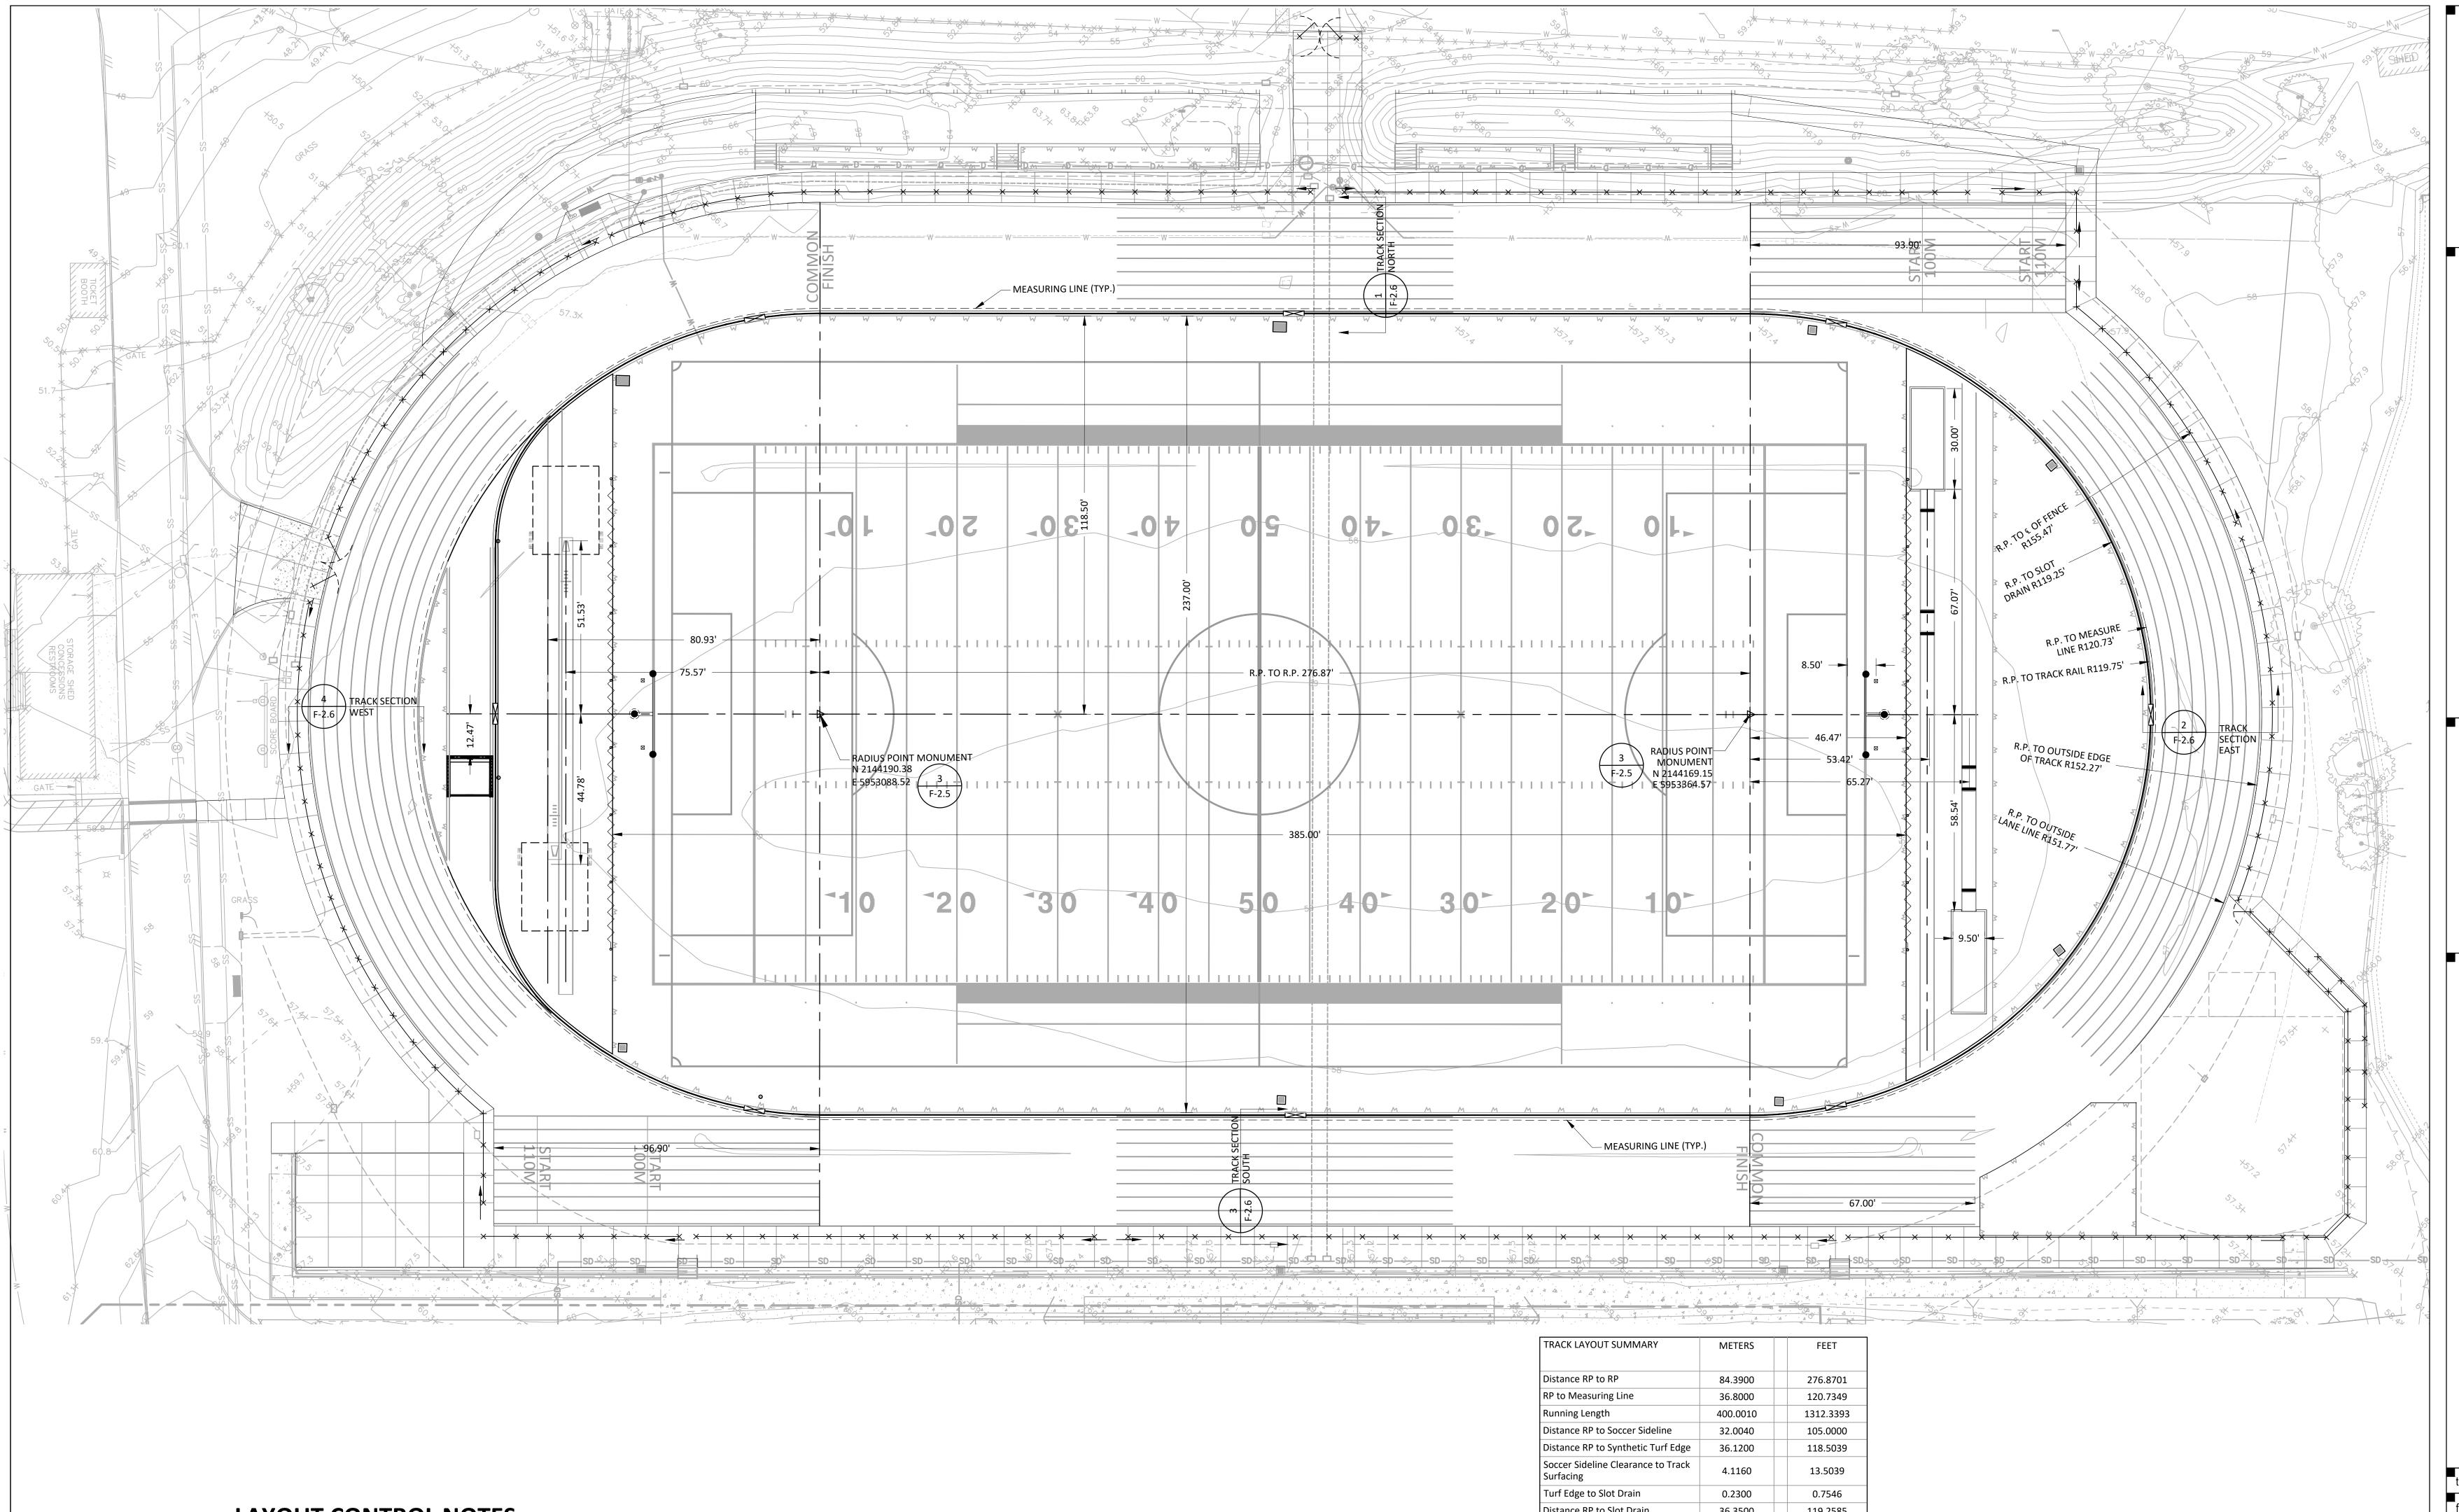


LAYOUT CONTROL NOTES

- 1. THE FOLLOWING CRITICAL LAYOUT & CONSTRUCTION STAKING TO BE PERFORMED BY A LICENSED PROFESSIONAL ENGINEER FROM ELECTRONIC DATA PROVIDED BY THE ENGINEER: TRACK RADIUS POINT MONUMENTS, CHAIN LINK FENCING CORNER POSTS, STORM DRAINAGE STRUCTURES, AND GRADING LIMITS. STAKE THESE ELEMENTS FOR ENGINEERS APPROVAL PRIOR TO CONTINUING THE WORK.
- 2. COORDINATE LAYOUT OF ALL UTILITIES WITH THAT OF EMBEDDED FEATURES INCLUDING BUT NOT LIMITED TO FENCE POSTS. WHERE IN CONFLICT, NOTIFY THE ENGINEER IMMEDIATELY BEFORE MAKING ADJUSTMENTS IN THE FIELD.
- 3. ALL SURFACE TRANSITIONS ARE FLUSH TO ADJACENT PROPOSED OR EXISTING SURFACES.
- 4. DIGITAL DESIGN DATA (AUTOCADD v2018; X,Y ONLY) WILL BE PROVIDED TO THE CONTRACTORS LICENSED LAND SURVEYOR FOR CONSTRUCTION STAKING.
- 5. LAYOUT COORDINATES ARE BASED ON THE OWNERS SUPPLIED PROFESSIONAL SURVEY.
- 6. COORDINATE WITH CIVIL FOR DRAINAGE STRUCTURES AND DRINKING FOUNTAIN LOCATION.
- 7. SEE F-1.1 FOR GENERAL LAYOUT OF THE PROPOSED FEATURES AND SURFACES.

8. SEE F-1.5 FOR FENCING PLANS FOR DETAILED GATE AND FENCING INFORMATION.

Running Length	400.0010	1312.3393
Distance RP to Soccer Sideline	32.0040	105.0000
Distance RP to Synthetic Turf Edge	36.1200	118.5039
Soccer Sideline Clearance to Track Surfacing	4.1160	13.5039
Turf Edge to Slot Drain	0.2300	0.7546
Distance RP to Slot Drain	36.3500	119.2585
Slot Drain to Track Rail	0.1500	0.4921
Distance RP to Track Rail	36.5000	119.7507
Track Rail to Measuring Line	0.3000	0.9843
Distance RP to Measuring Line	36.8000	120.7349
Lane Width	1.2200	4.0026
Distance RP to Lane 2 Line	37.7200	123.7533
Lane Width	1.2200	4.0026
Distance RP to Lane 3 Line	38.9400	127.7559
Lane Width	1.2200	4.0026
Distance RP to Lane 4 Line	40.1600	131.7585
Lane Width	1.2200	4.0026
Distance RP to Lane 5 Line	41.3800	135.7612
Lane Width	1.2200	4.0026
Distance RP to Lane 6 Line	42.6000	139.7638
Lane Width	1.2200	4.0026
Distance RP to Lane 7 Line	43.8200	143.7664
Lane Width	1.2200	4.0026
Distance RP to Lane 8 Line	45.0400	147.7690
Lane Width	1.2200	4.0026
Distance RP to Outside Lane Line	46.2600	151.7717
Lane Line + Additional Surfacing	0.1524	0.5000
Distance RP to Edge of Surfacing	46.4124	152.2717
Outside Lane Line to Fence Face	1.0650	3.4941
Width of Fence	0.1250	0.4101
Distance RP to Fence CL	47.3875	155.4708

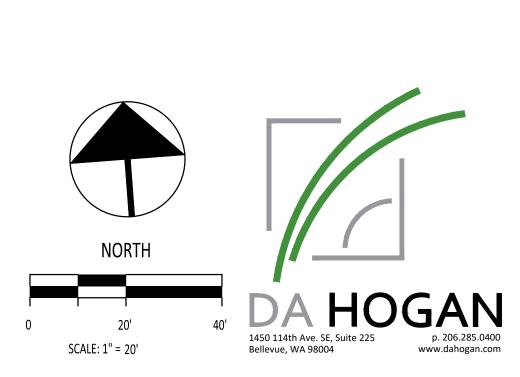



tBP project number: 22079.00

file name:

drawn by: CPW checked by: RSH

date: 12-06-23

rev: date: description:

09/08/23 SCHEMATIC DWGS

10/09/23 DESIGN DEVELOPMENT DWGS

11/01/23 75% CONSTRUCTION DWGS

11/20/23 DSA SUBMITTAL

12/06/23 BID SET


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drawing title:

FIELD AND TRACK

LAYOUT CONTROL PLAN

F-1.6

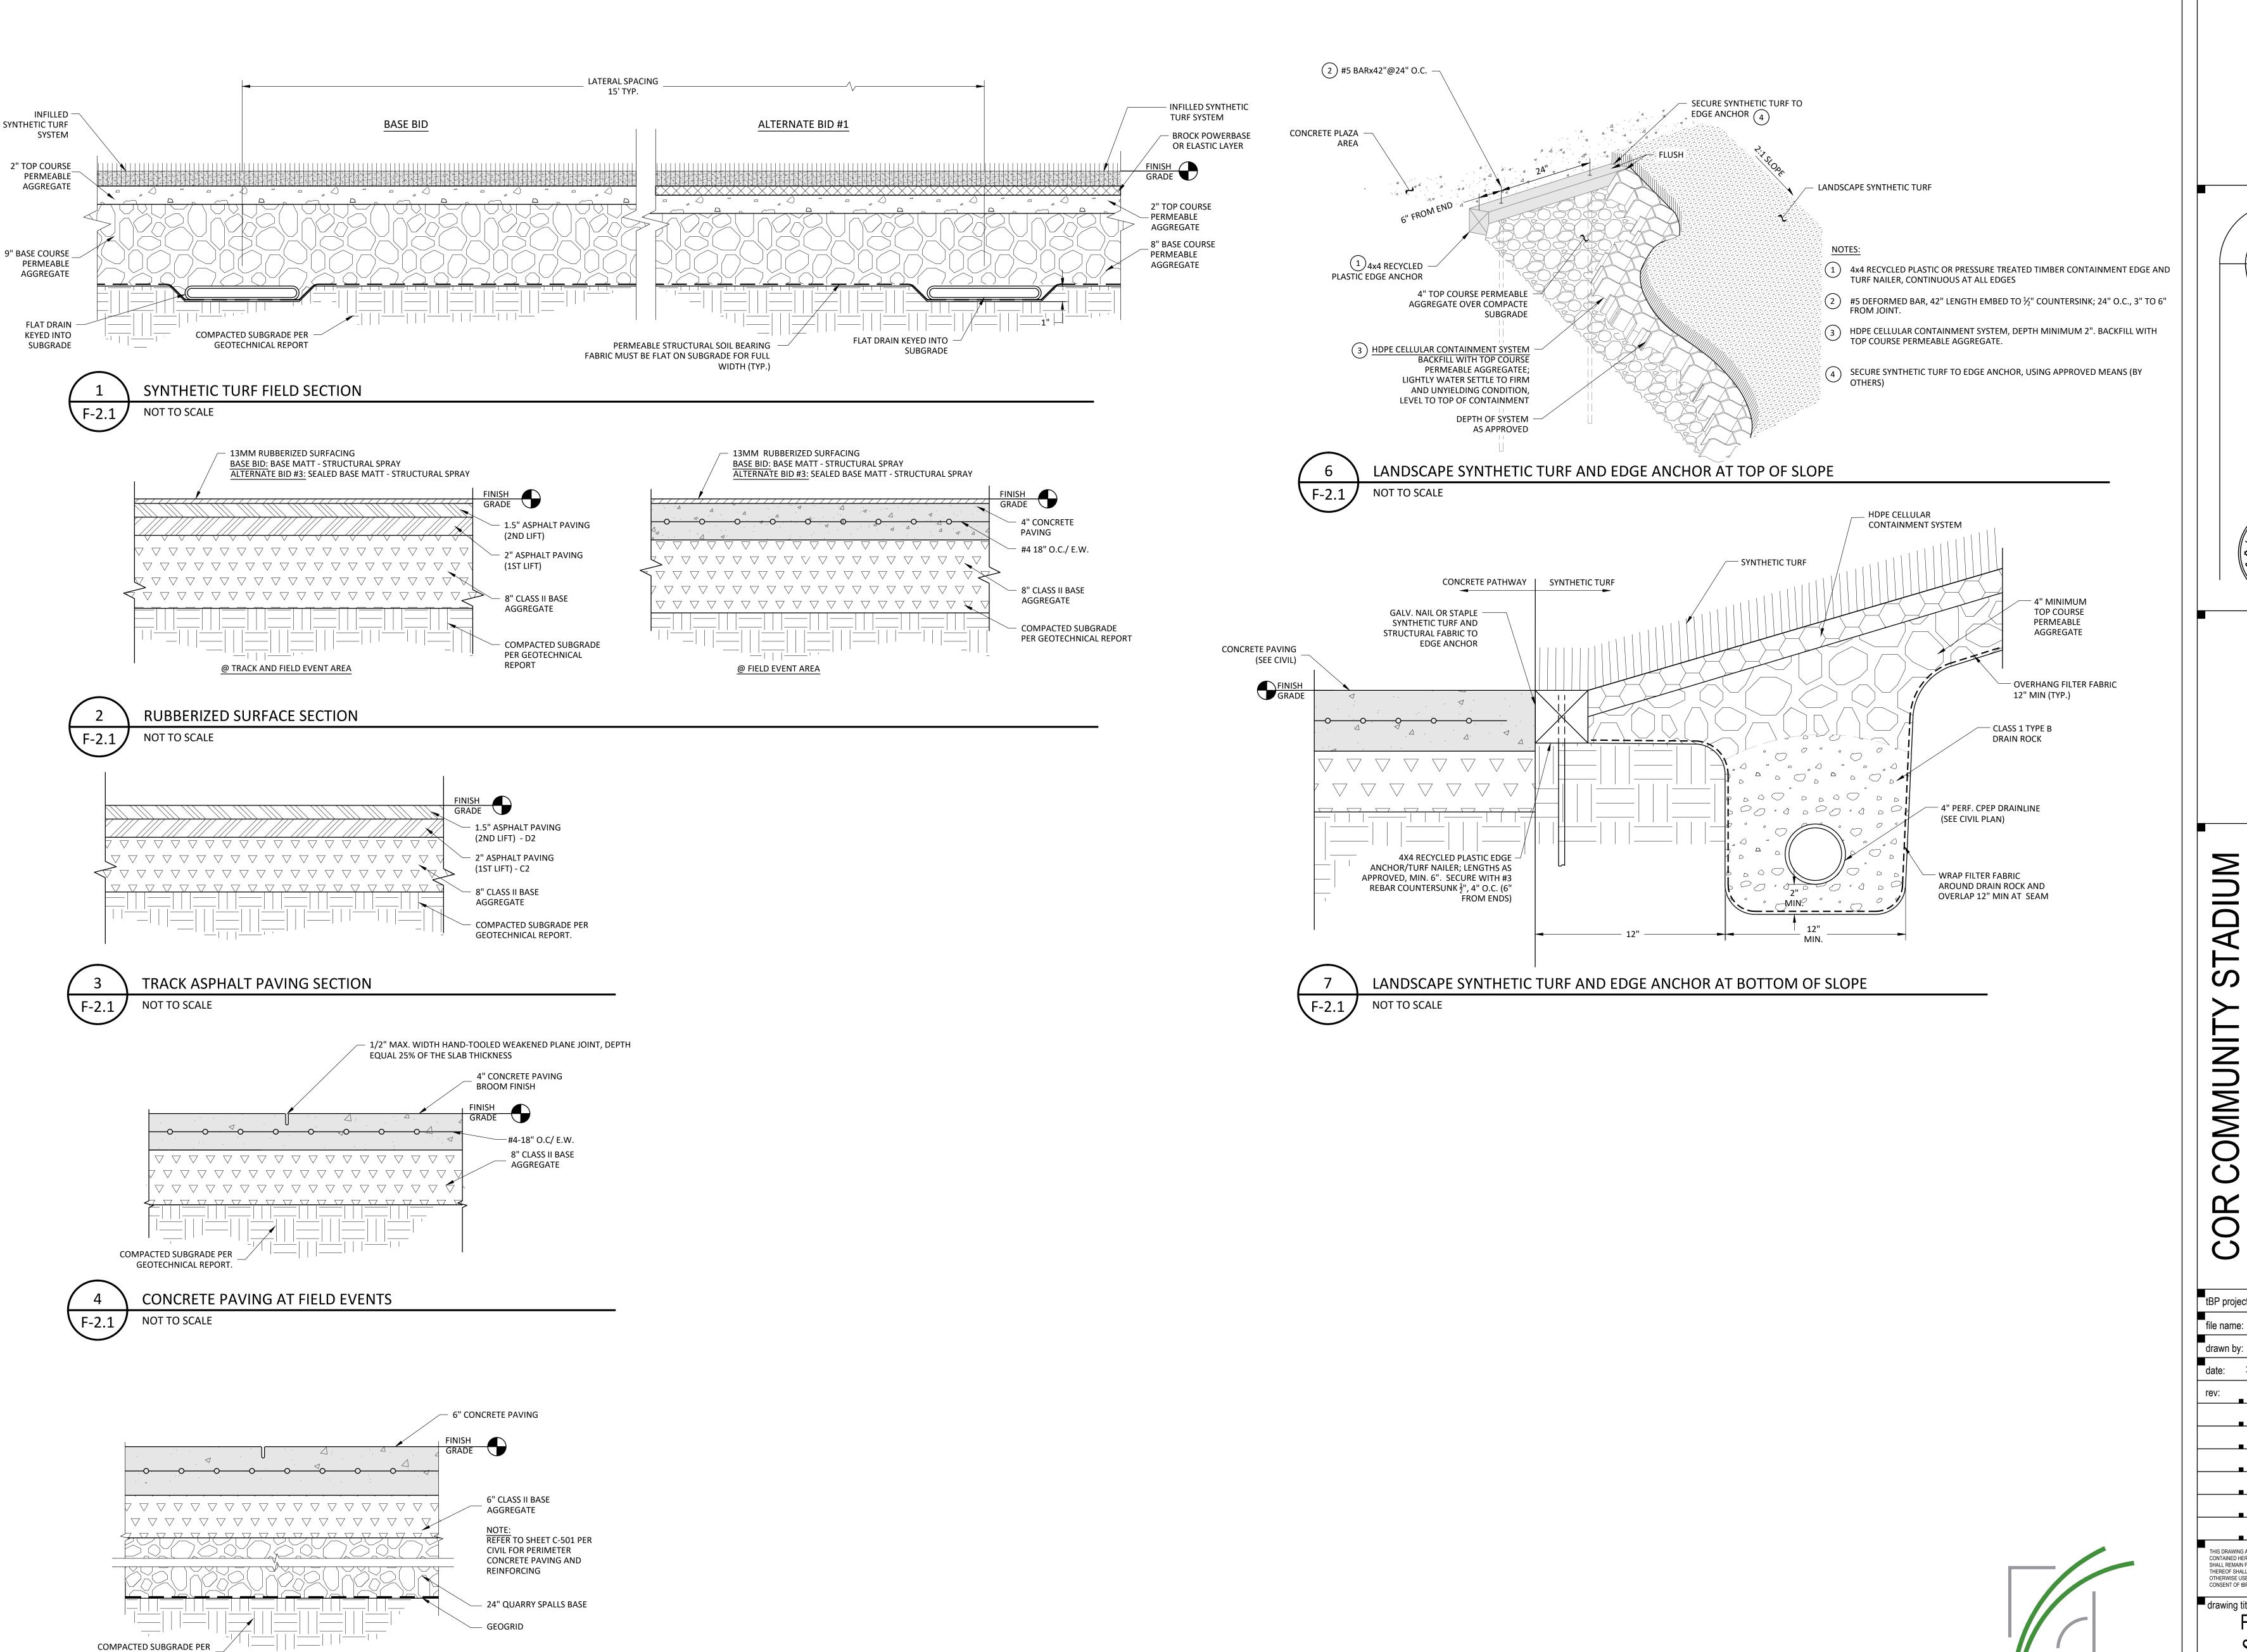

GEOTECHNICAL REPORT.

F-2.1

NOT TO SCALE

CONCRETE PAVING WITH QUARRY SPALLS


tBP project number: 22079.00 file name: drawn by: LRB checked by: RSH date: 12-06-23 date: 09/08/23 SCHEMATIC DWGS 10/09/23 DESIGN DEVELOPMENT DWGS 11/01/23 75% CONSTRUCTION DWGS _ 11/20/23 _ DSA SUBMITTAL _ 12/06/23 _ BID SET CONTAINED HEREIN CONSTITUTE UNPUBLISHED WORK OF tBP/ARCHITECTURE AND SHALL REMAIN PROPERTY OF tBP/ARCHITECTURE IN PERPETUITY. NO PART THEREOF SHALL BE REPRODUCED, DISCLOSED, DISTRIBUTED, SOLD, PUBLISHED OR OTHERWISE USED IN ANY WAY WITHOUT THE ADVANCED EXPRESS WRITTEN CONSENT OF tBP/ARCHITECTURE.


DA HOGAN


FIELD AND TRACK SECTION DETAILS


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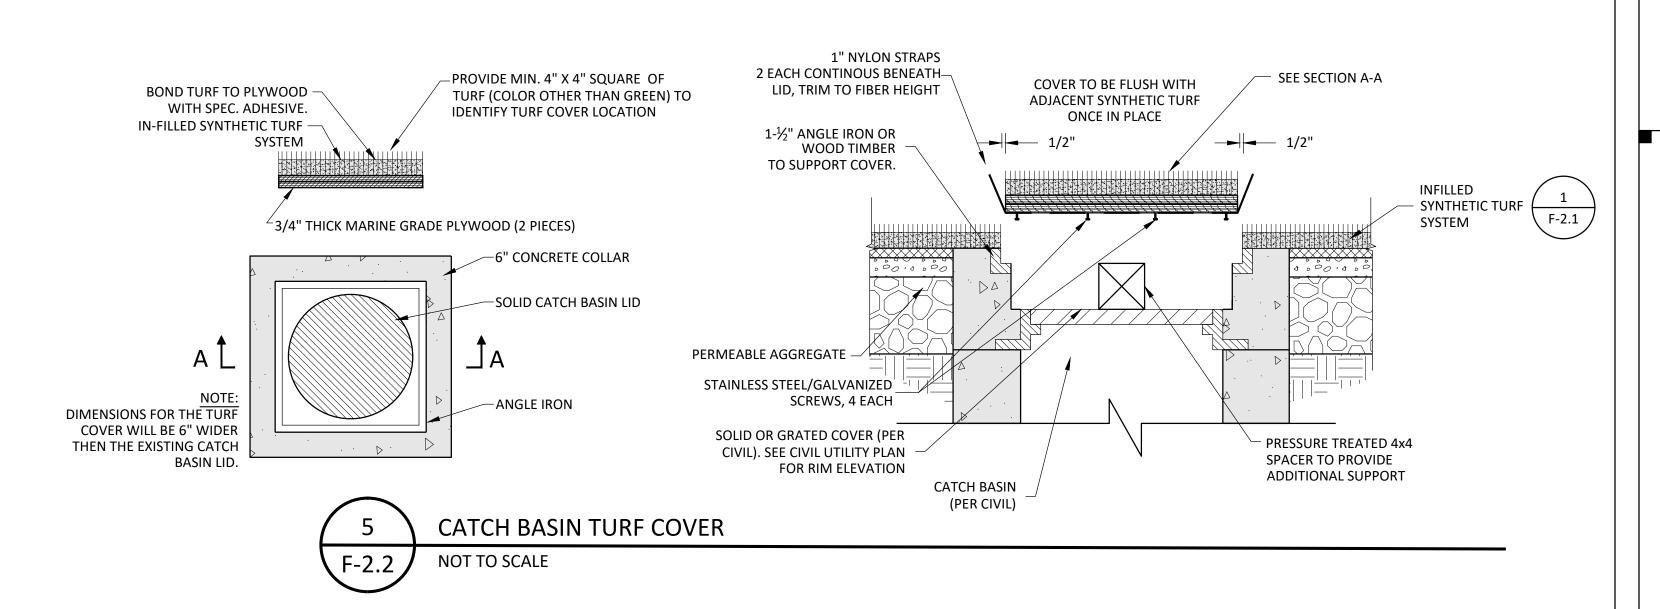
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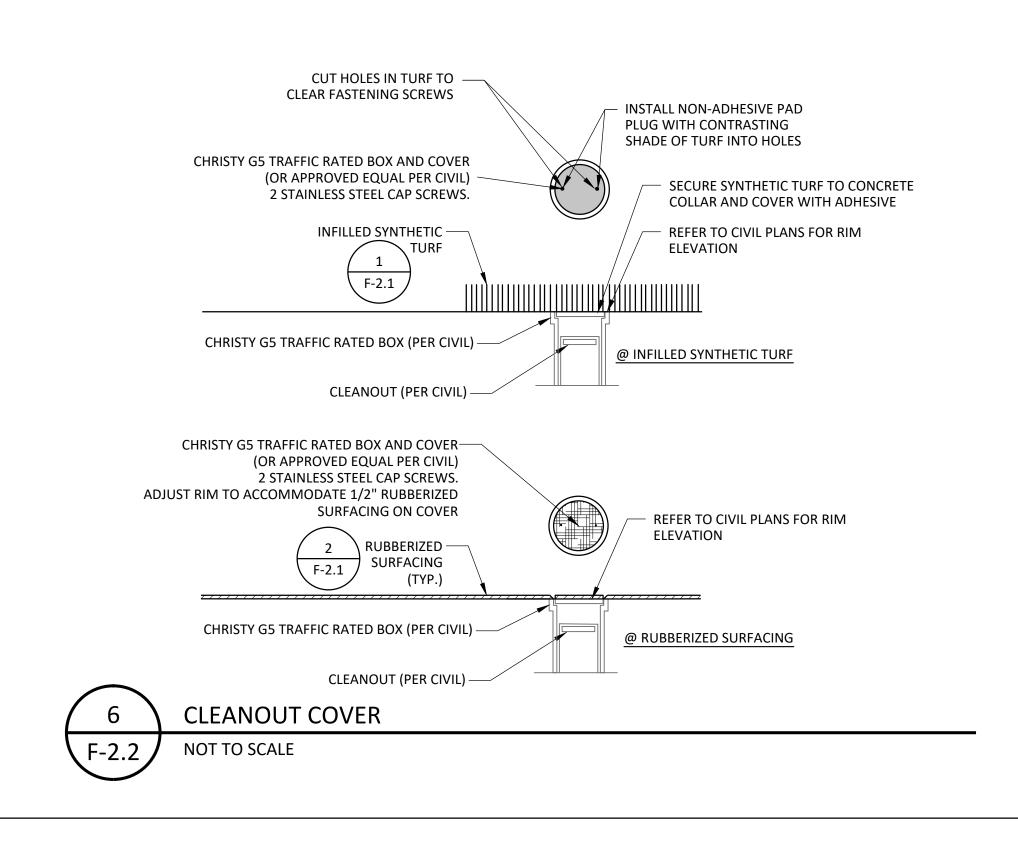




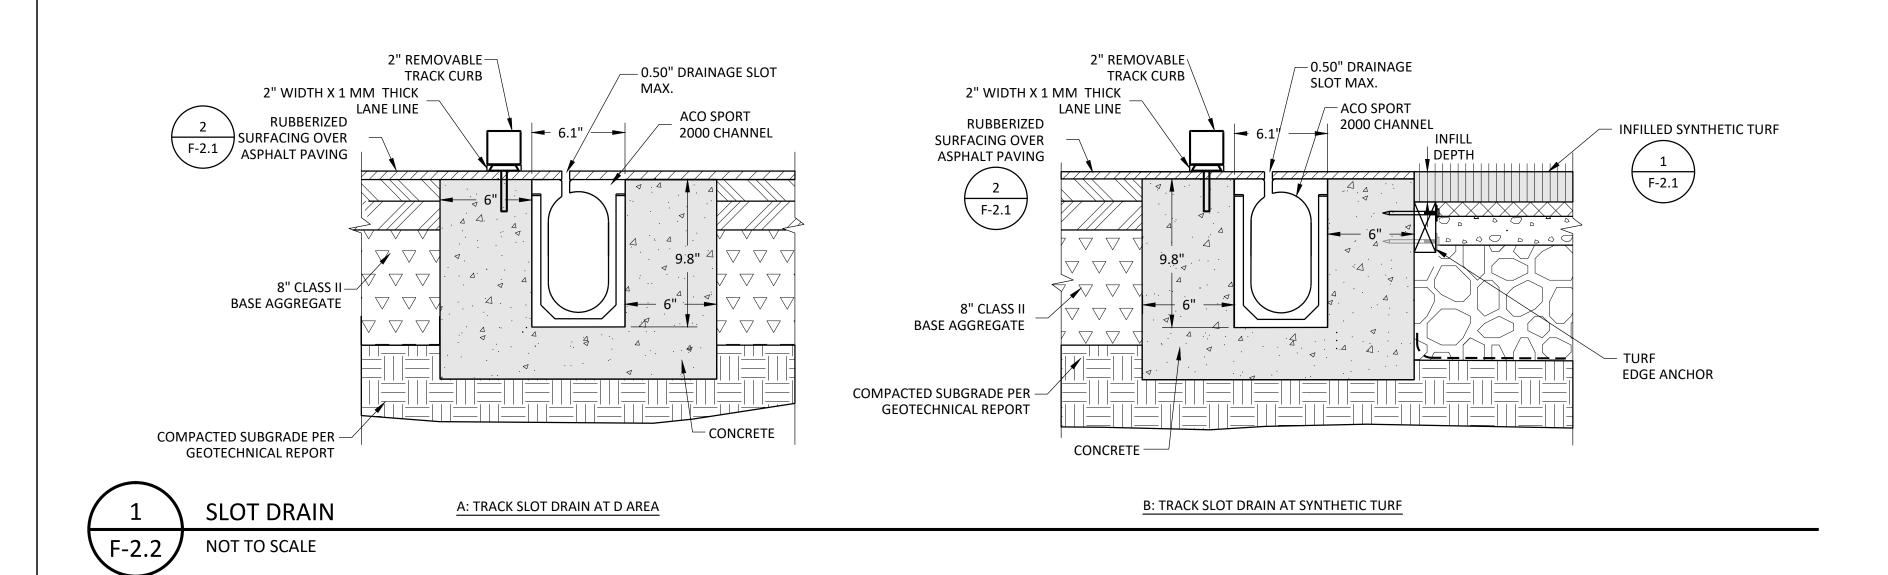


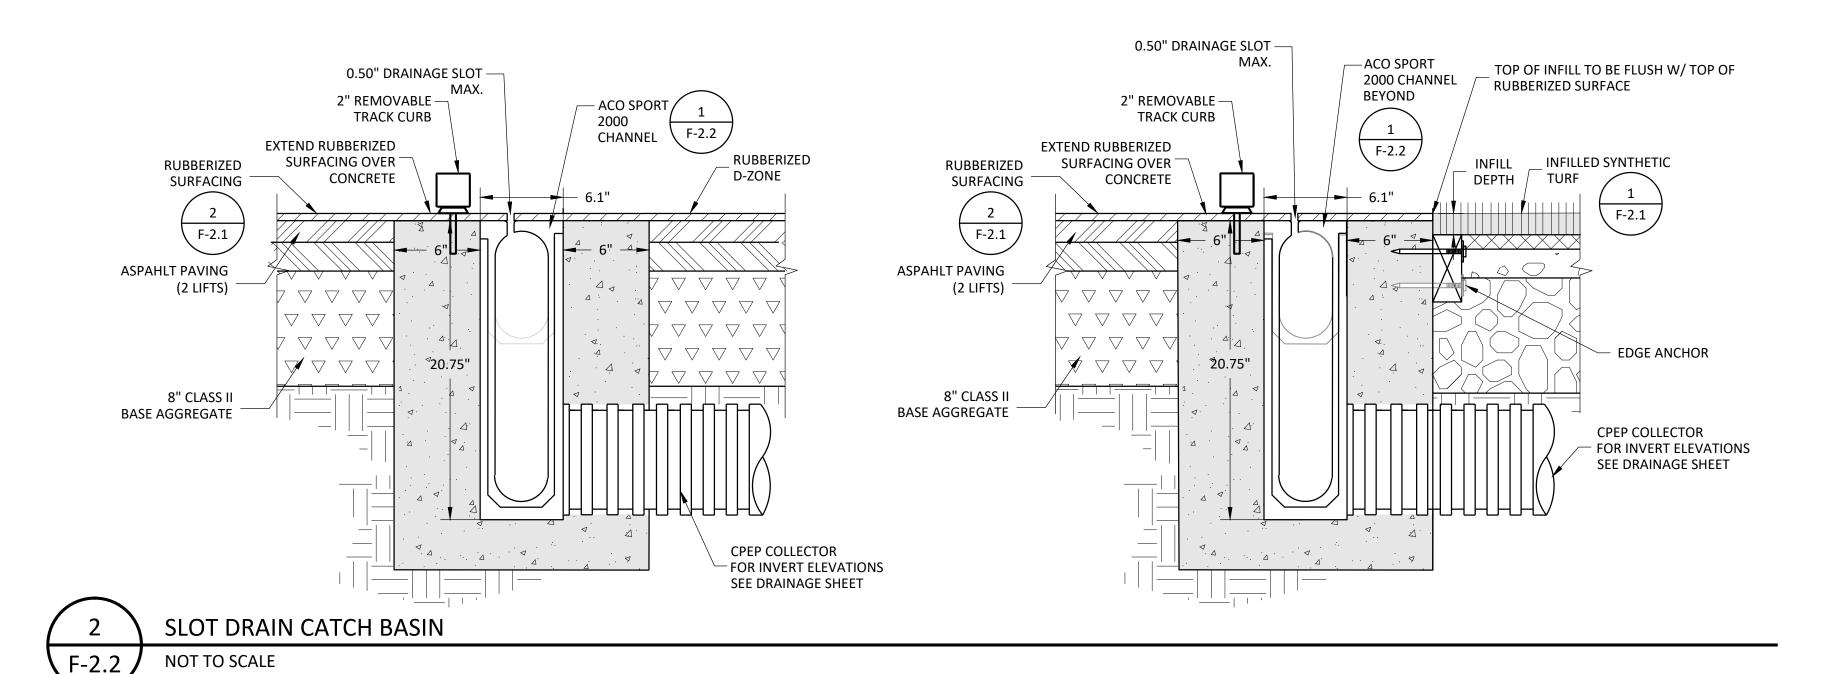


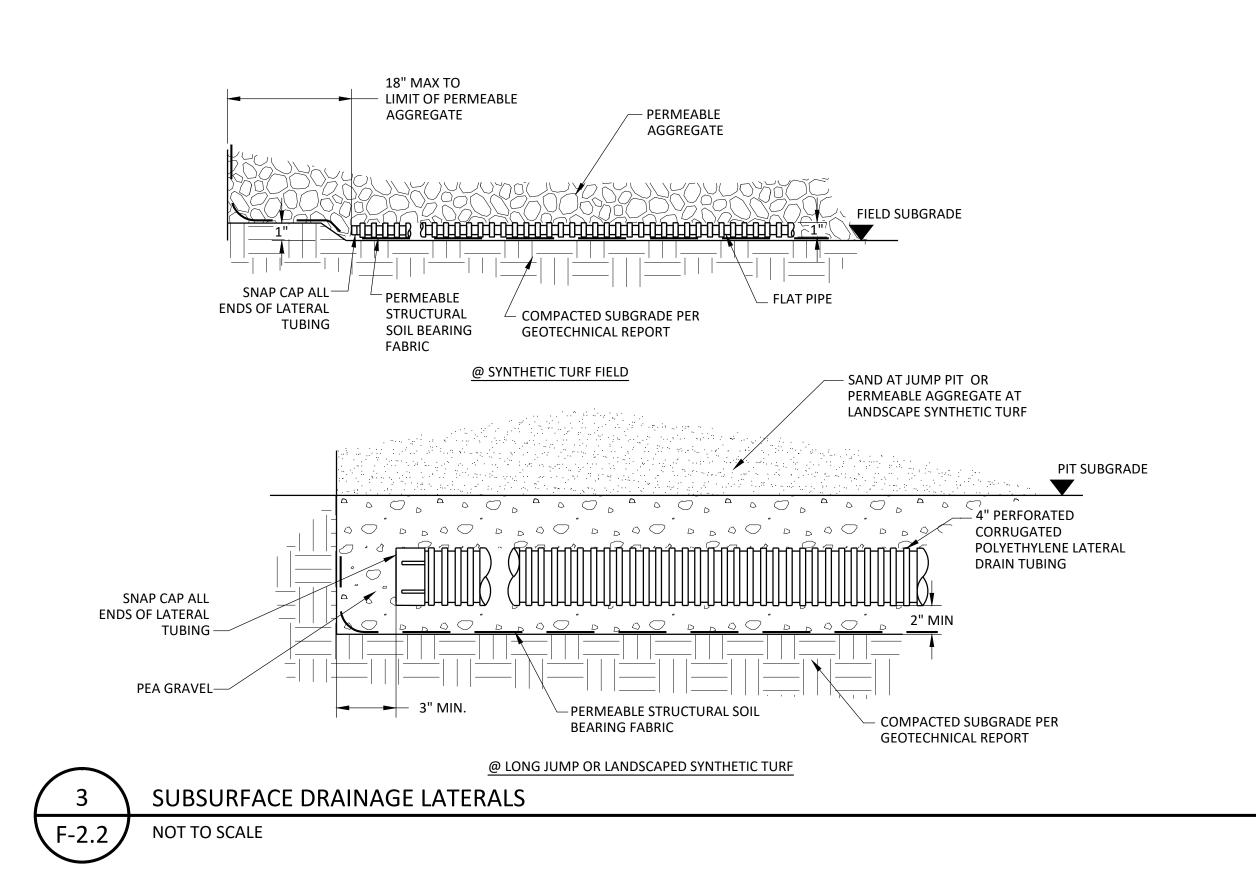

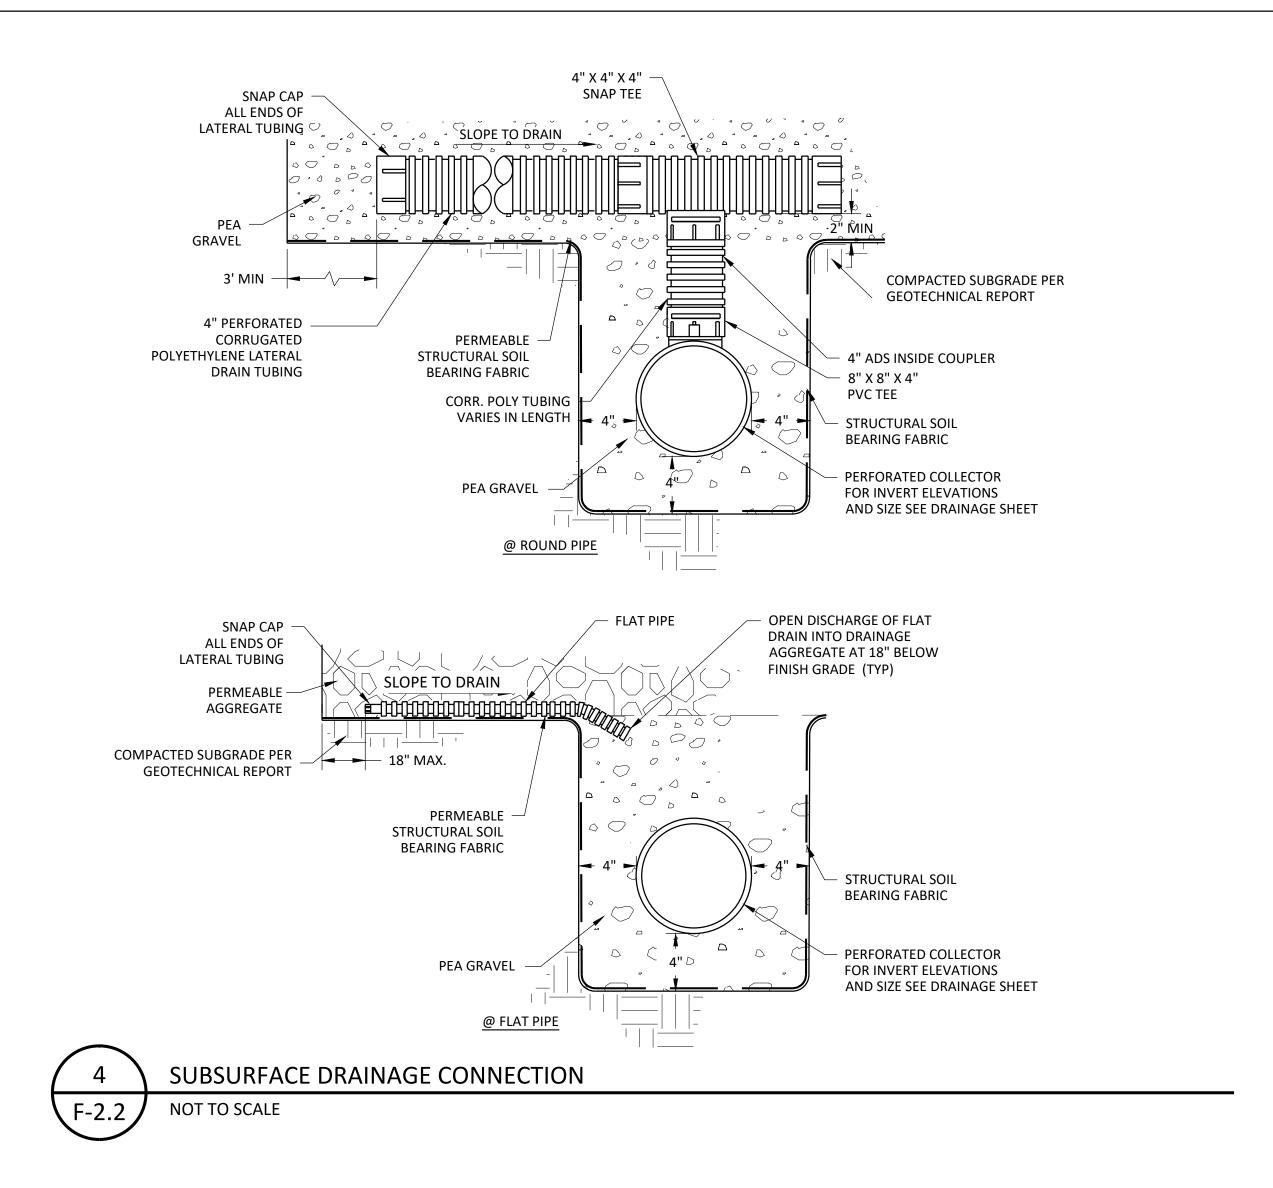



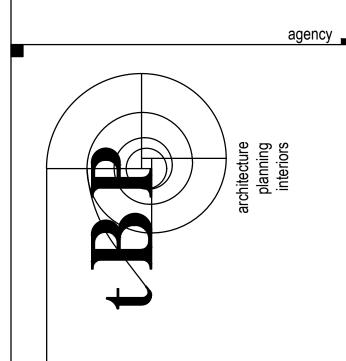

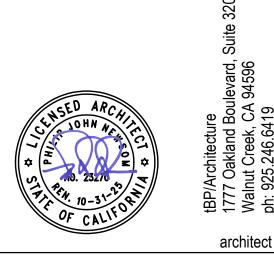



consultant

OR COMMUNITY STADIUM
UPGRADE

OLEGE OF THE REDWOODS

tBP project number: 22079.00

file name:

drawn by: CPW checked by: RSH

date: 12-06-23

rev: date: description:

09/08/23 SCHEMATIC DWGS

10/09/23 DESIGN DEVELOPMENT DWGS


11/01/23 75% CONSTRUCTION DWGS


11/20/23 BID SET

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FIELD AND TRACK
DRAINAGE DETAILS

drawing no.:



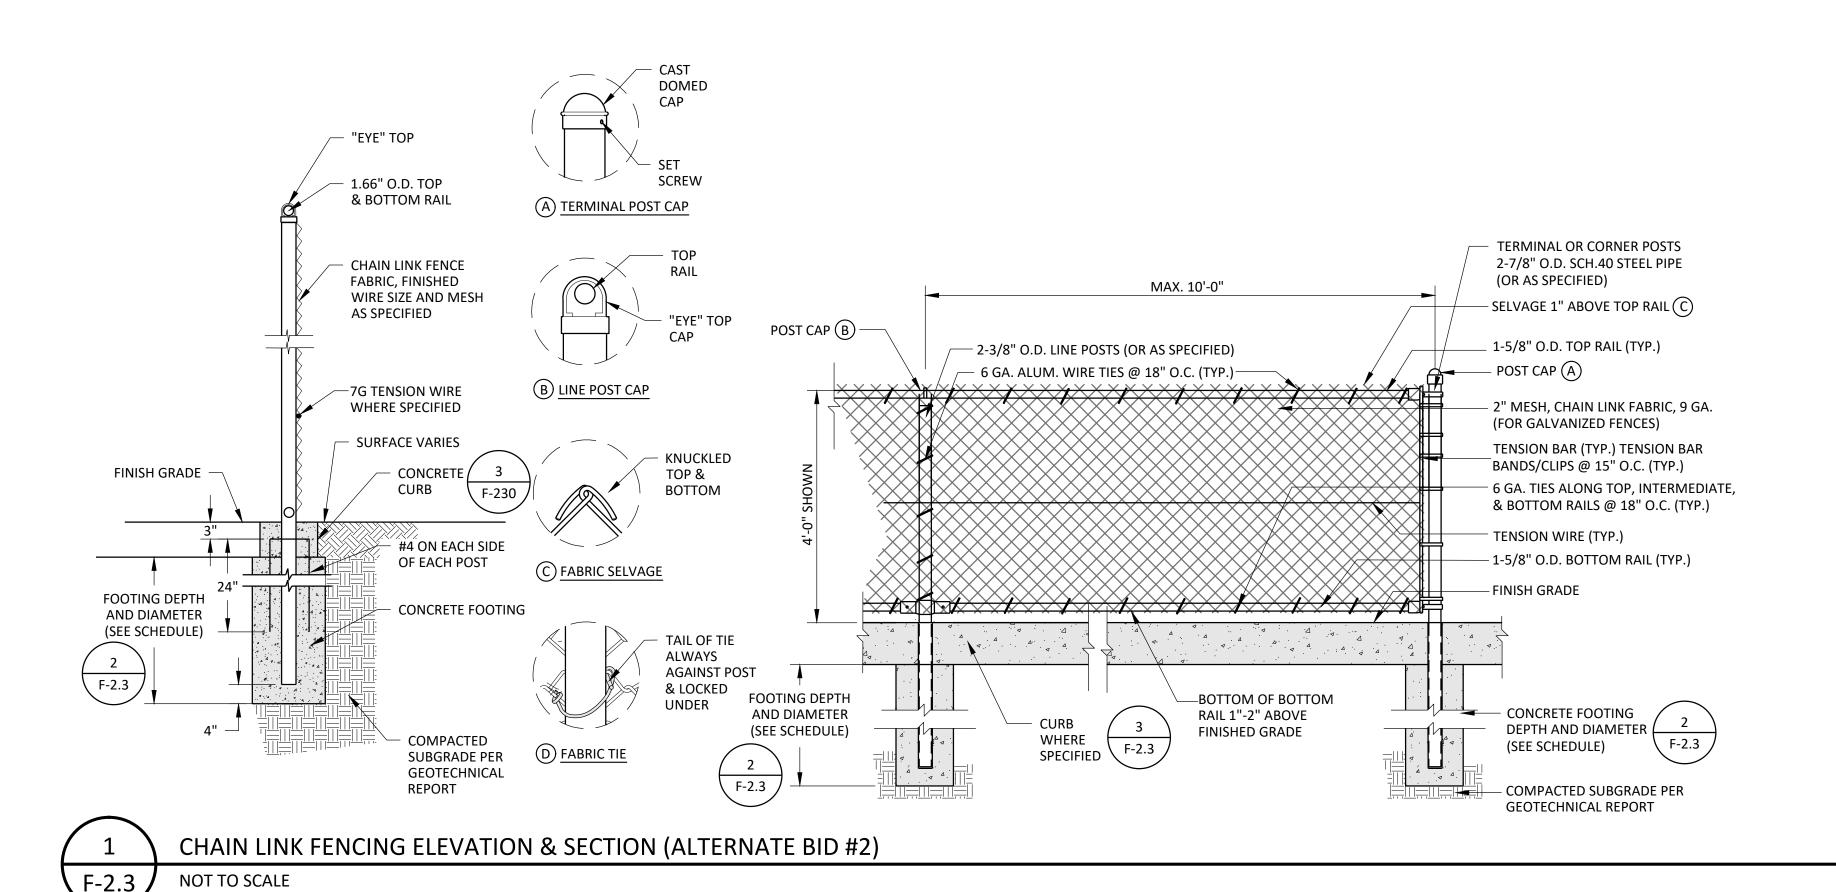

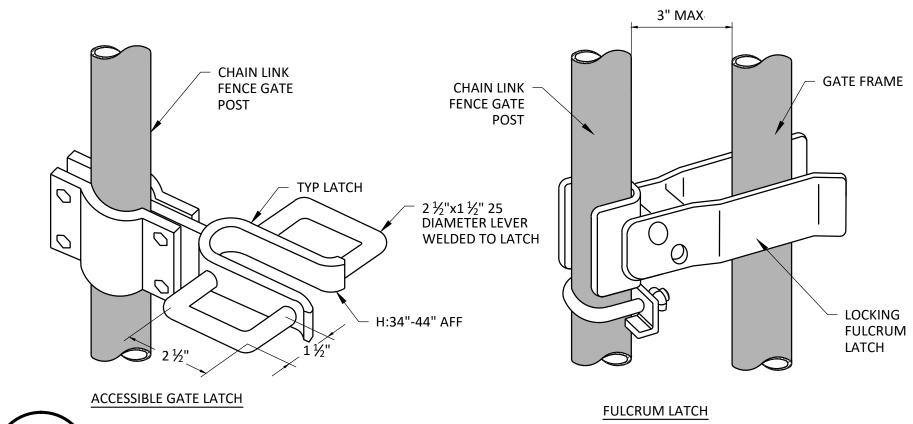4 GATE LATCH (ALTERNATE BID #2)

F-2.3 NOT TO SCALE

CORNER POST
TERMINAL POST
LINE POST
FOOTING DEPTH
FOOTING DIAMETER
TOP RAIL HT.
INTERMEDIATE RAIL HTS.
BOTTOM RAIL HT
TENSION WIRE HTS.

2.875" OD
2.875" OD
2.375" OD
30"
12"
4'
12"
1"
2'

FENCING NOTES:

1. ALL FENCING FABRIC SHALL BE 2" MESH NO. 9 GAUGE FINISHED STEEL WIRES WITH BLACK VINYL COATING.

2. ALL POSTS, RAILS, BRACES, POST TOPS, STRETCHER BARS, BANDS, ETC. SHALL BE PAINTED BLACK.

TENSION MIDES AND MIDE TIES SHALL INCLUDE A BLACK VINYL COATING.

3. TENSION WIRES AND WIRE TIES SHALL INCLUDE A BLACK VINYL COATING.


MAXIMUM POST SPACING: 10' ON CENTER.
 ALIGN POSTS SO THAT FENCE FABRIC IS INSTALLED IN A CONTINUOUS, STRAIGHT LINE, REGARDLESS

OF FENCE POST DIAMETER


6. ALL POSTS SHALL BE ASTM A53, GRADE B, SCHEDULE 40 UNLESS NOTED OTHERWISE


6. ALL POSTS SHALL BE ASTM A53, GRADE B, SCHEDULE 40 UNLESS NOTED OTHERWISE


2 CHAIN LINK SCHEDULE (ALTERNATE BID #2)
F-2.3 NOT TO SCALE

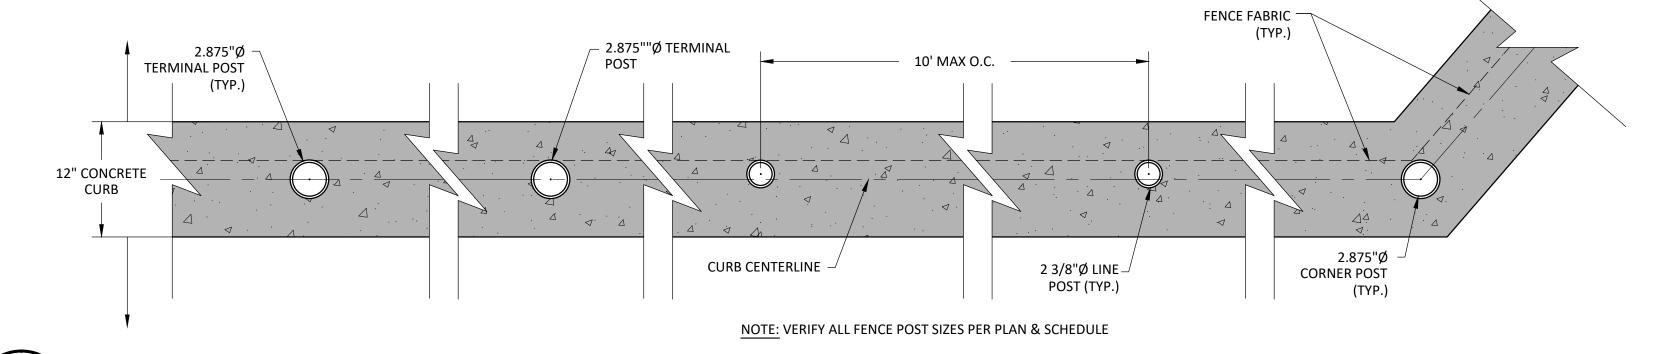


5 TYPICAL FENCE POST LAYOUT (ALTERNATE BID #2)
-2.3 NOT TO SCALE

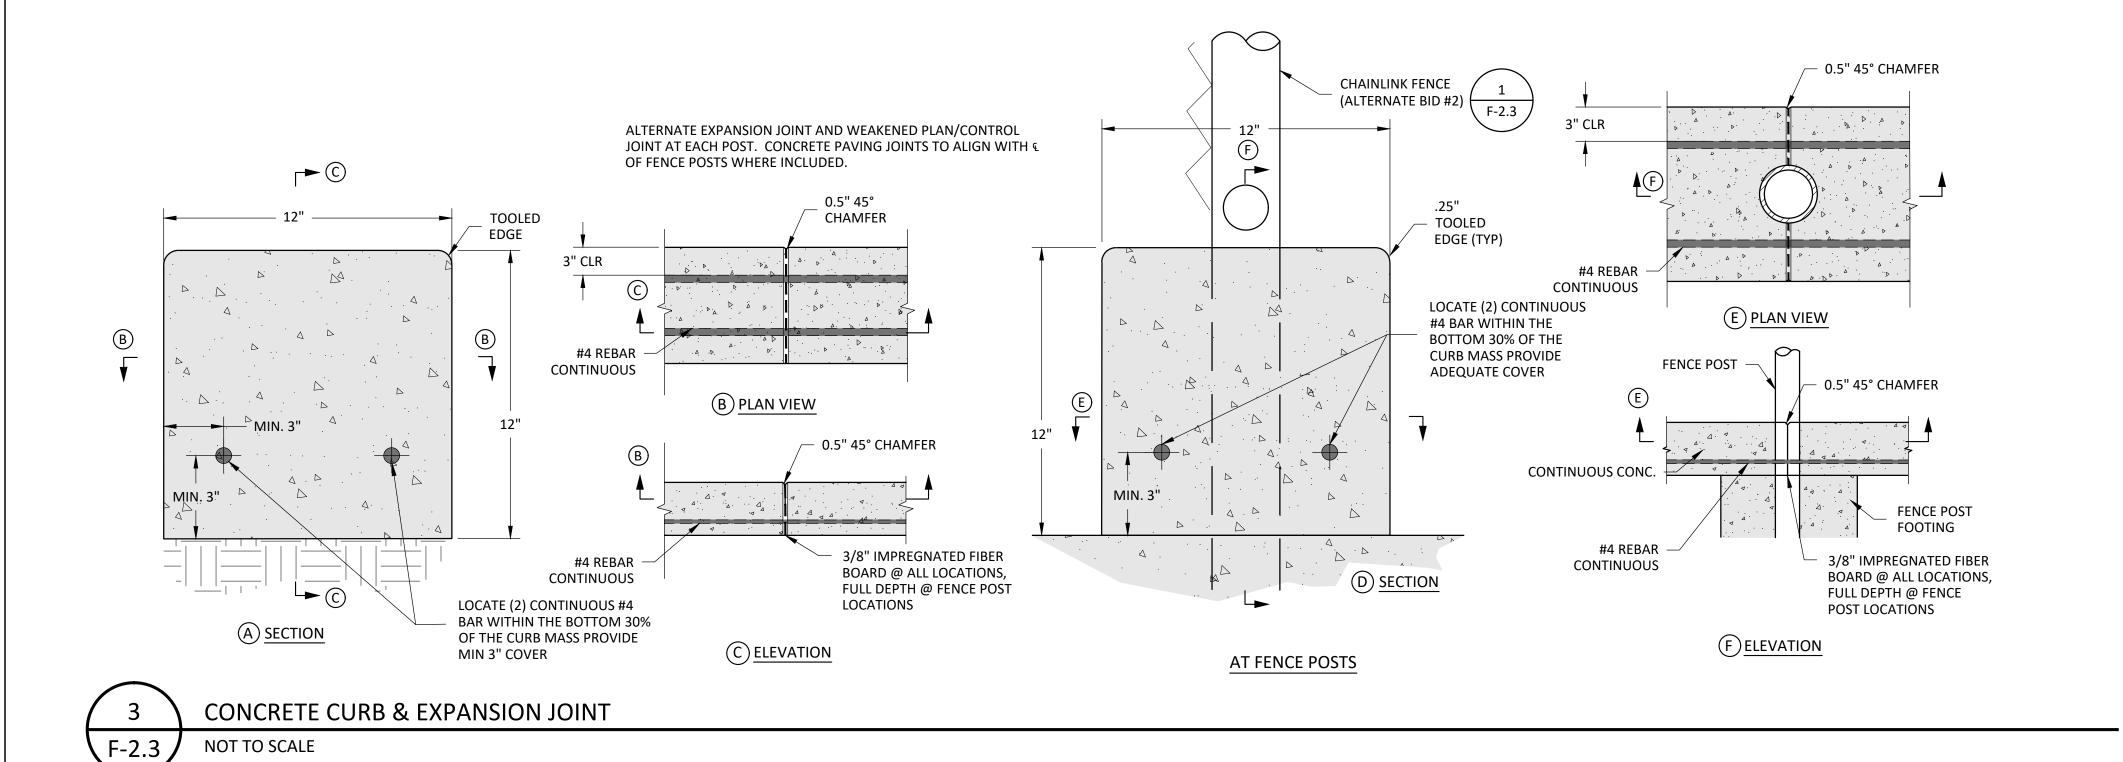

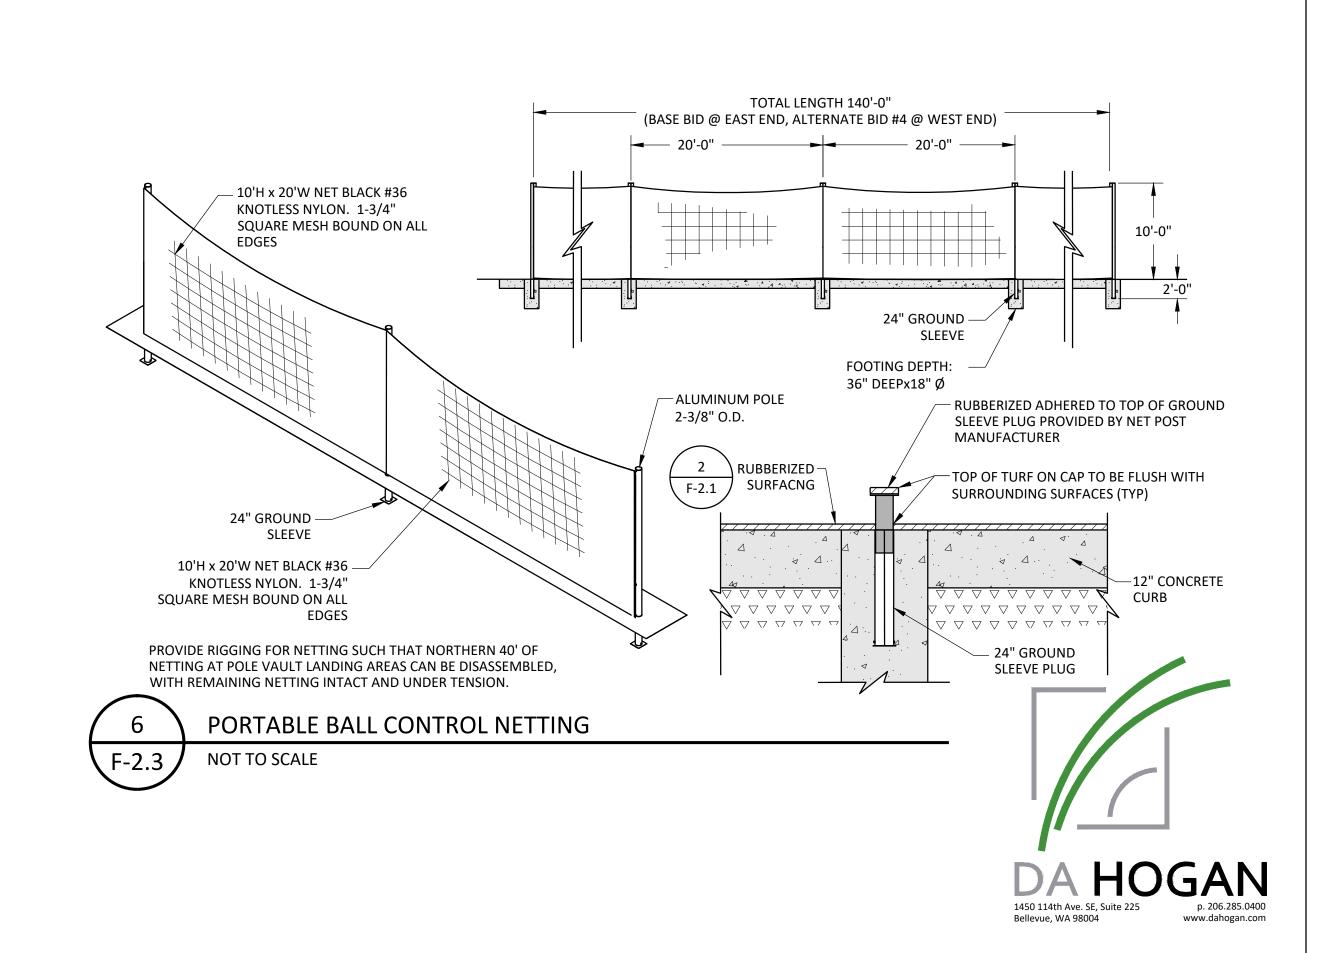

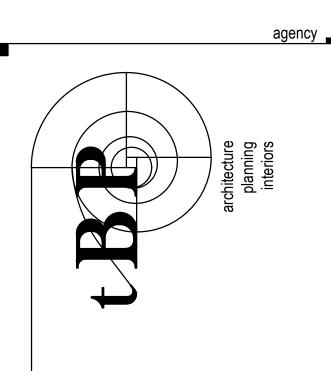

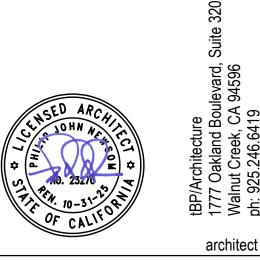



COMMUNITY STADIUM
UPGRADE
EGE OF THE REDWOODS

tBP project number: 22079.00

file name:

drawn by: CPW checked by: RSH

date: 12-06-23

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09/08/23 SCHEMATIC DWGS

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11/01/23 75% CONSTRUCTION DWGS
11/20/23 DSA SUBMITTAL
12/06/23 BID SET


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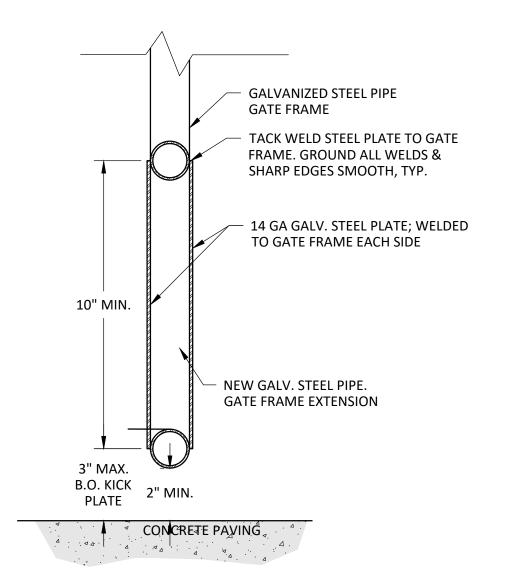
drawing title:

FIELD AND TRACK
FENCING DETAILS

drawing no.:



NOT TO SCALE

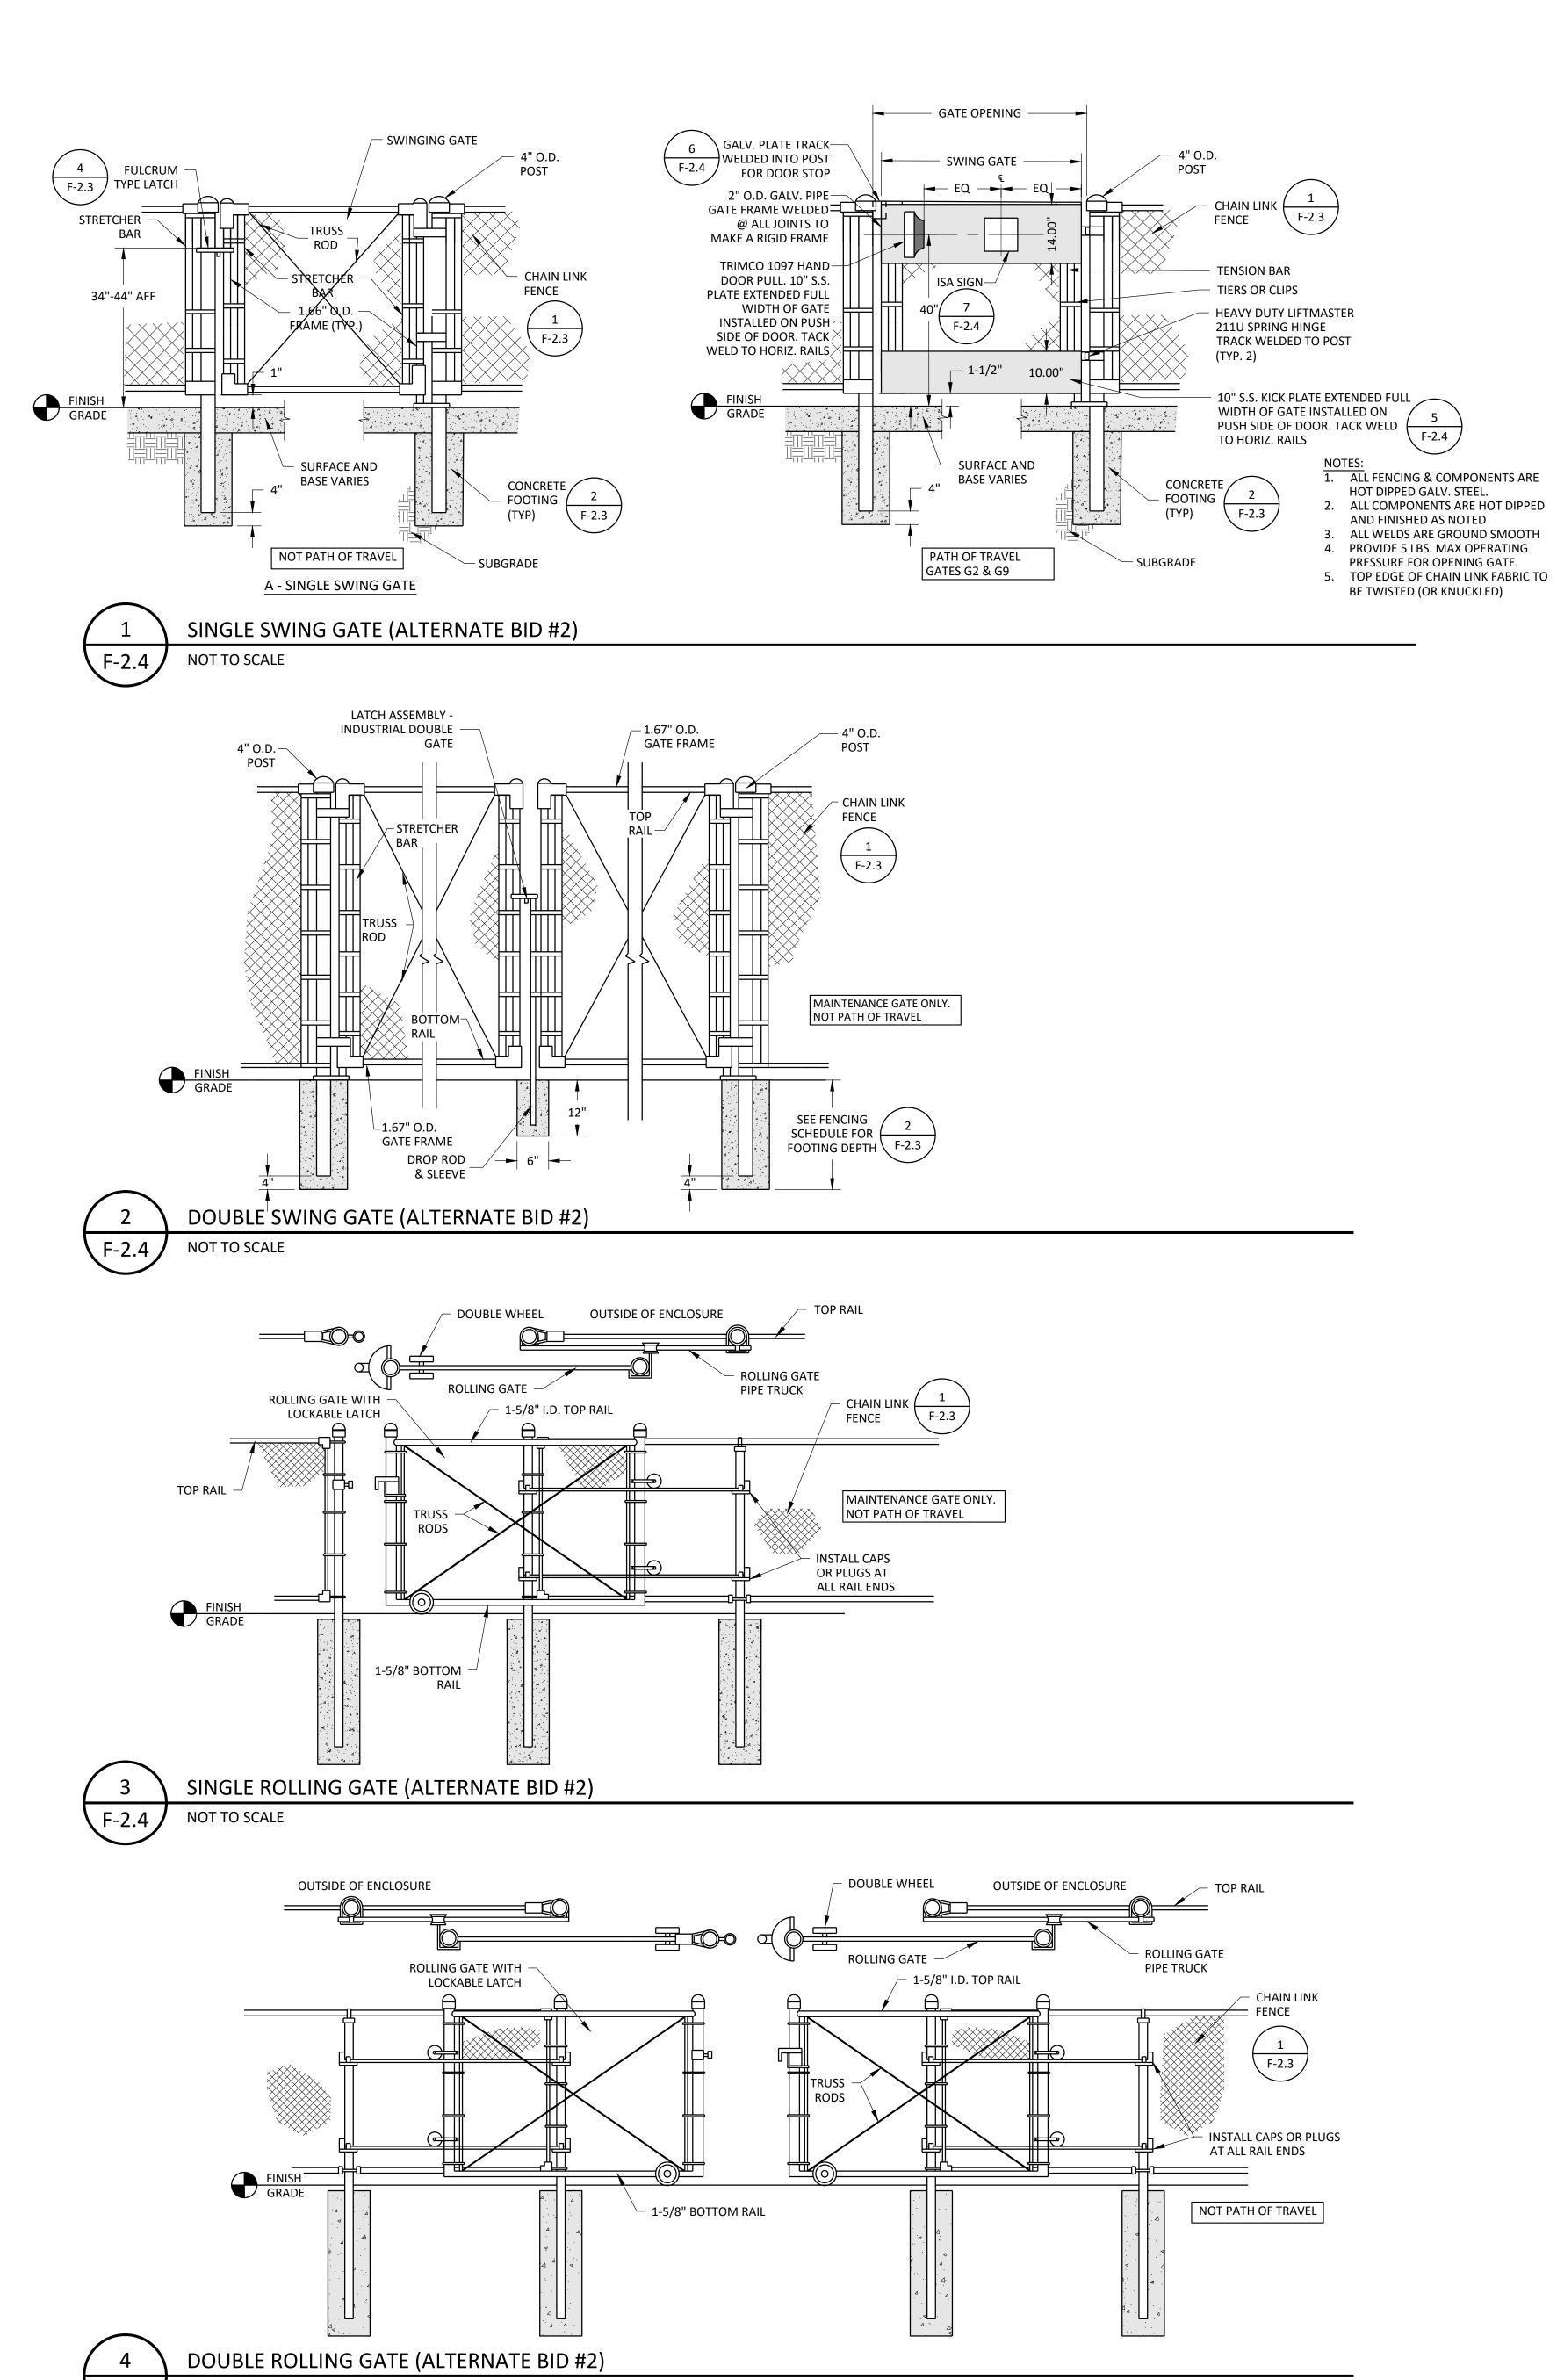

5 KICK PLATE SECTION (ALTERNATE BID #2)

NOT TO SCALE

F-2.4

F-2.4

4"x4" 1/4" GALV. PLATE, TACK
WELDED INTO CHAIN LINK POST


CHAIN LINK FENCE

TRIMCO 1097 HAND DOOR PULL.

10" S.S. PLATE EXTENDED FULL


GATE SECTION (ALTERNATE BID #2)
NOT TO SCALE


WIDTH OF GATE INSTALLED ON PUSH SIDE OF DOOR. TACK WELD TO HORIZ. RAILS

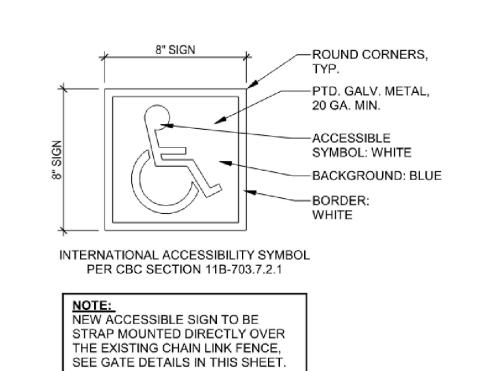

7 ISA SIGN FOR GATE (ALTERNATE BID #2)


F-2.4 NOT TO SCALE

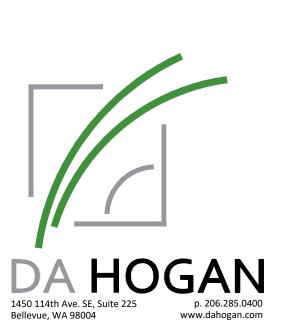

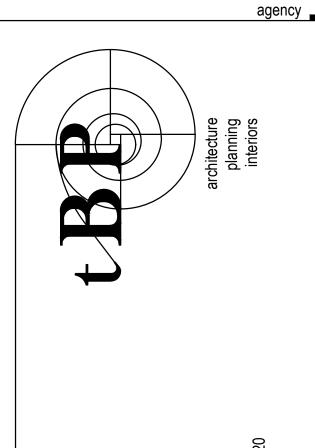

tBP/Architecture
1777 Oakland Boulevard, S
walnut Creek, CA 94596
ph: 925.246.6419



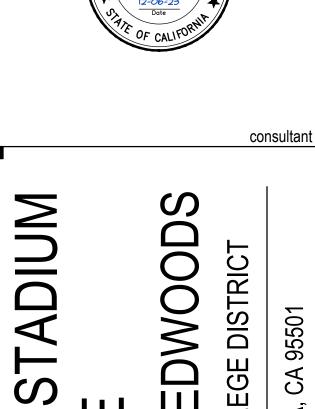

COLLEGE OF THE REDWOODS

REDWOODS COMMUNITY COLLEGE DISTRICT

COMMUNIT

COR

tBP project number: 22079.00

file name:

drawn by: LRB checked by: RSH

date: 12-06-23

rev: date: description:

09/08/23 SCHEMATIC DWGS


10/09/23 DESIGN DEVELOPMENT DWGS

11/01/23 75% CONSTRUCTION DWGS

11/20/23 BID SET

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FIELD AND TRACK
FENCING DETAILS

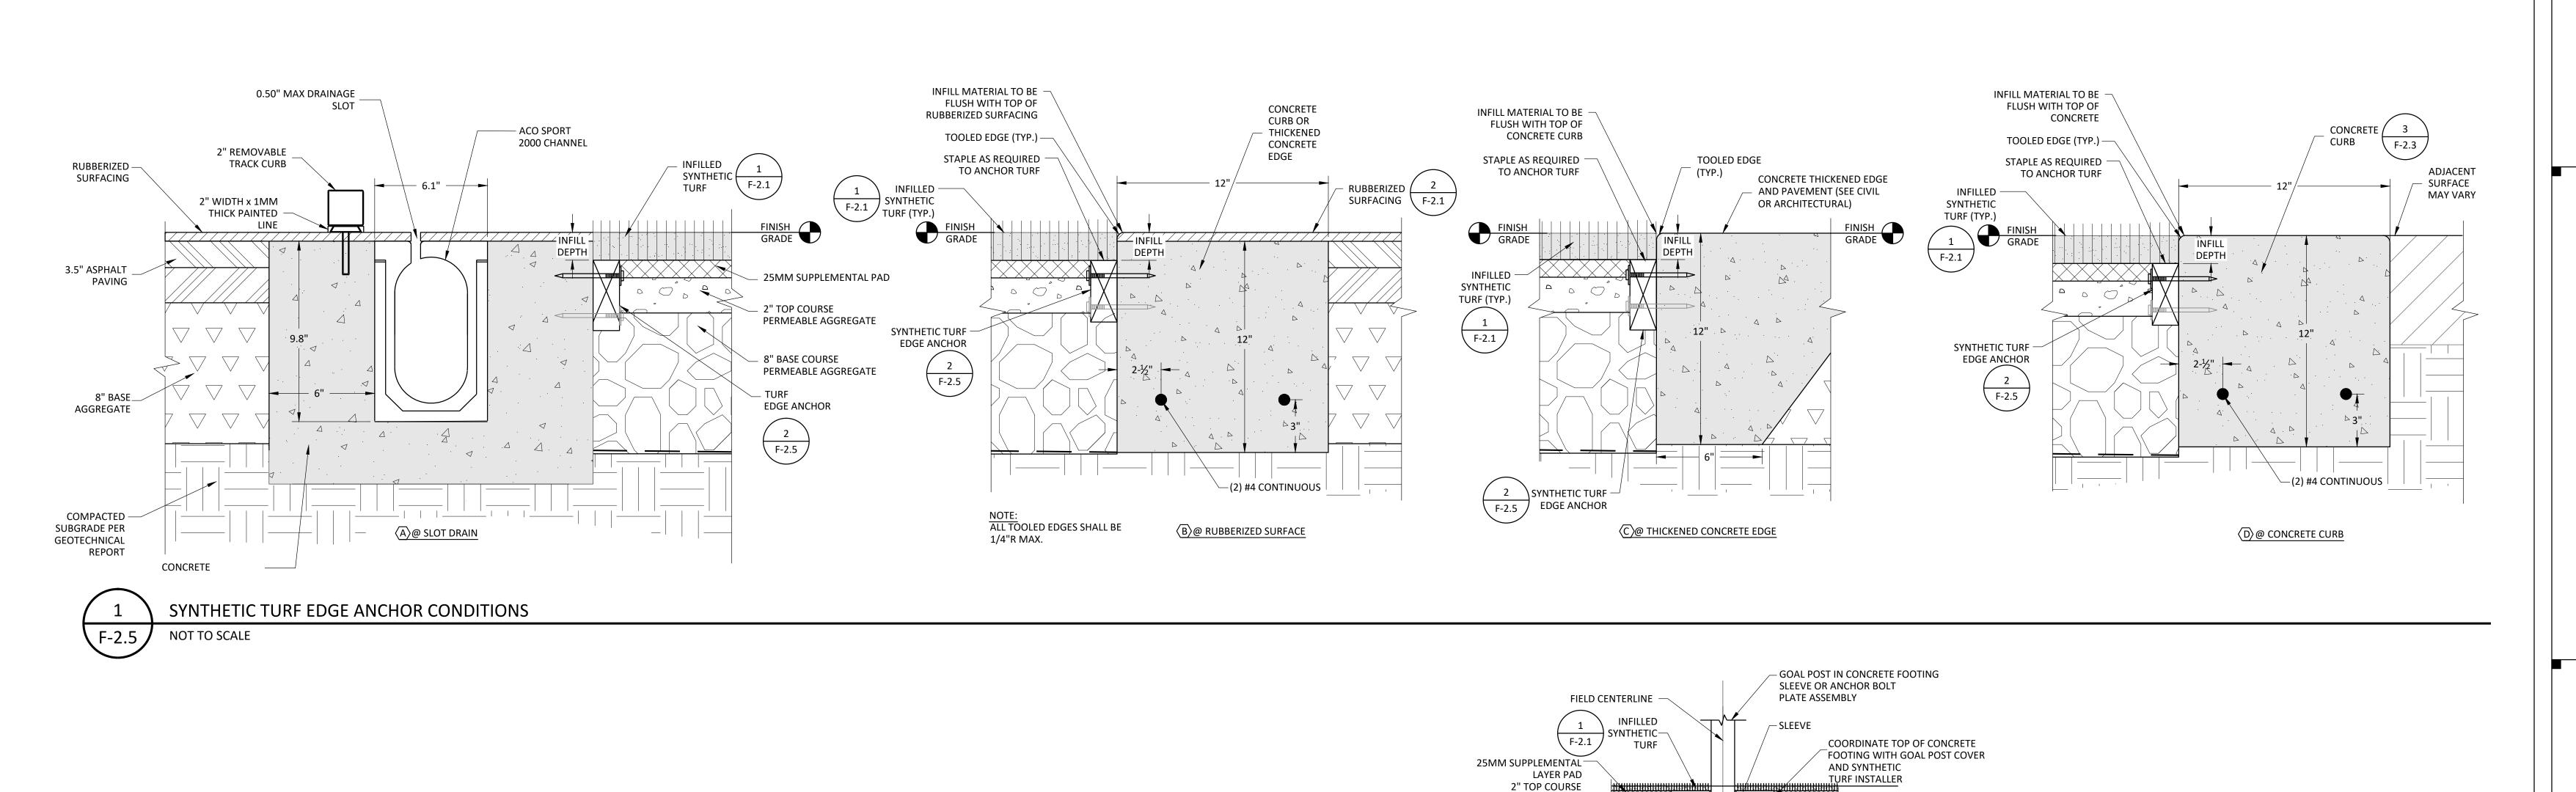

PERMEABLE AGGREGATE -

PERMEABLE AGGREGATE)

8" BASE COURSE

STRUCTURAL SOIL

BEARING FABRIC

CONCRETE GOAL POST

FOOTING SUPPORT

3' DIA. X 6'-0" DEPTH

ADJUST GOAL POST CROSSBAR TO 10.0' HT.

ABOVE FINISH FIELD GRADE

ACCOMMODATE BOLT.

TYPE INSTALLATION)

└─ SUBGRADE


INSTALL 1/2" DIA. GALV. BOLT TO


PROVIDE CLEARANCE IN GOAL POST


SLOT. NOTCH GOAL POST SLEEVE TO

(NOT REQUIRED FOR ANCHOR PLATE

PERMEABLE

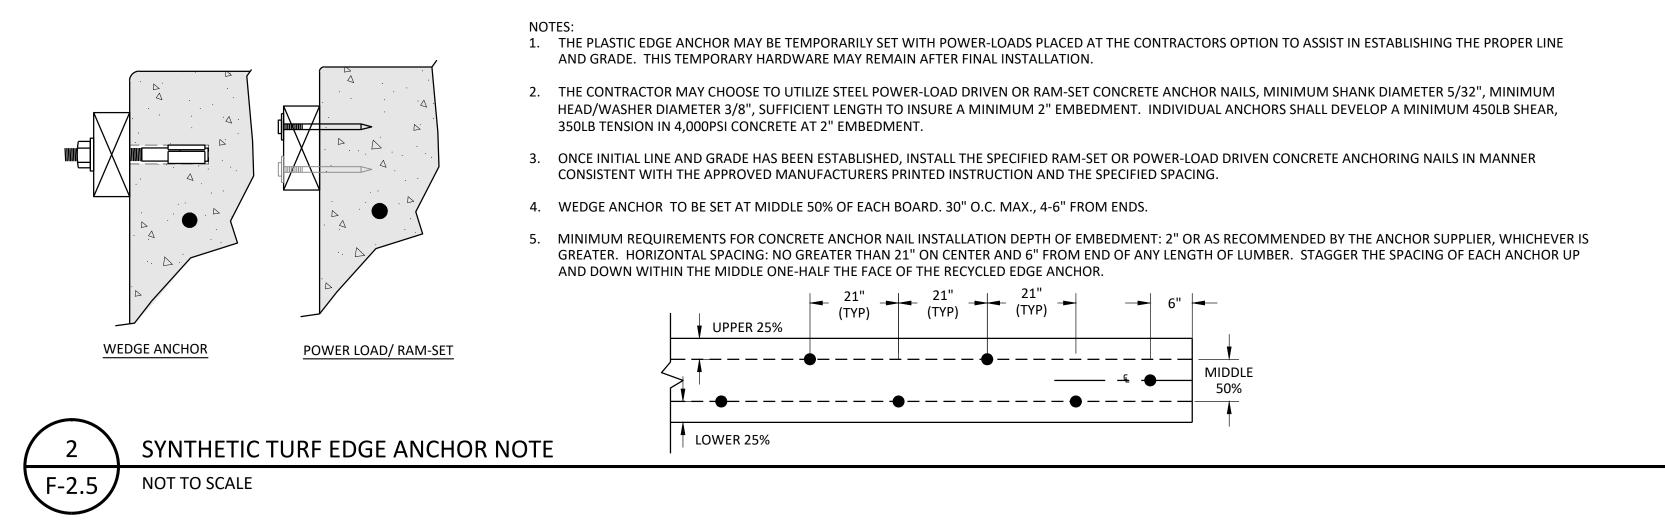

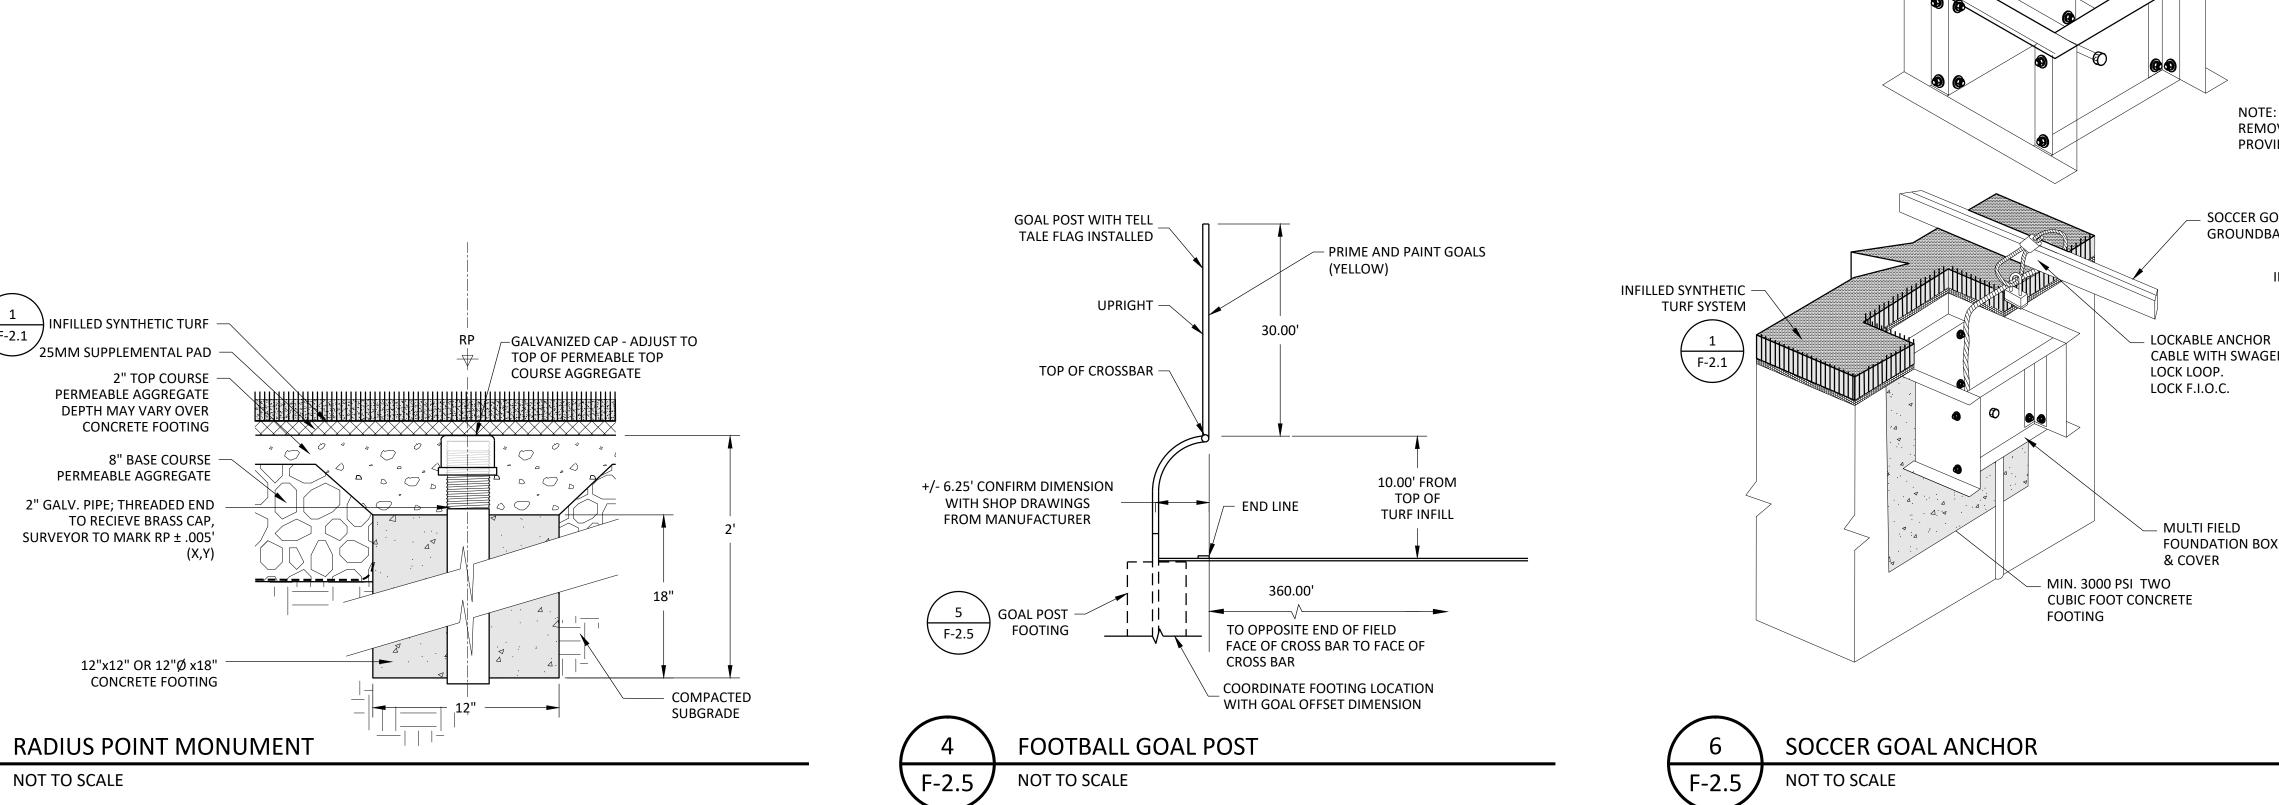

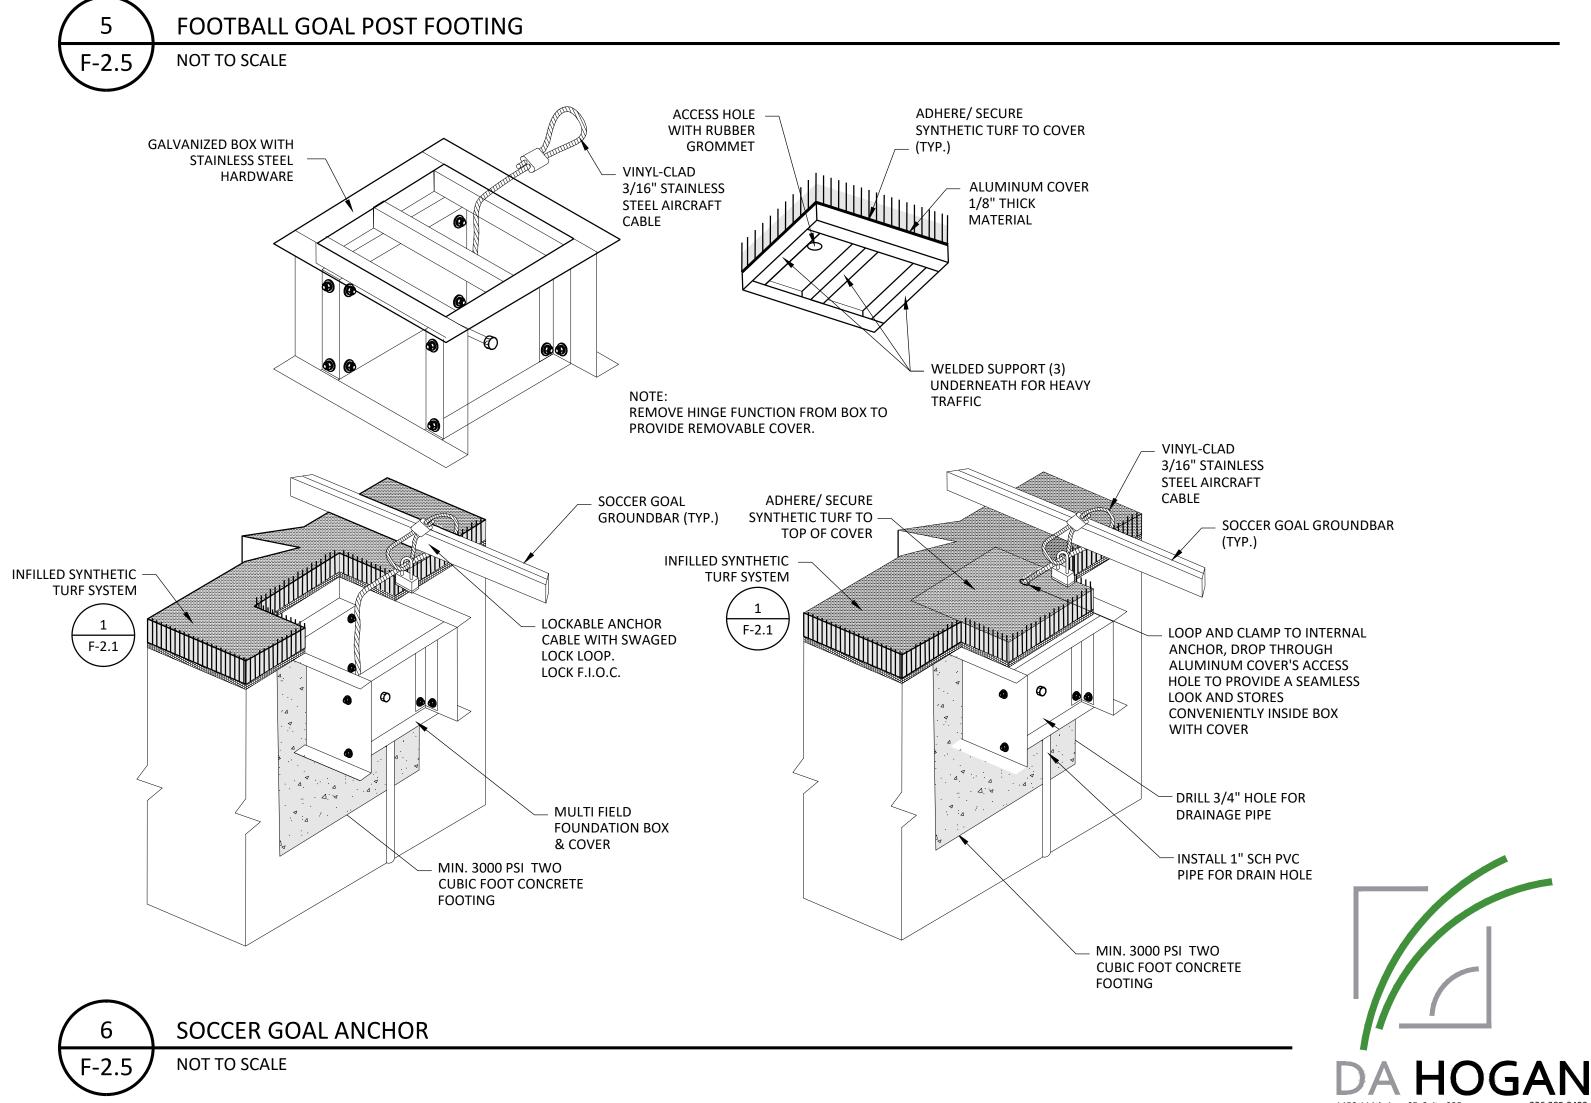

#5 REBAR (VERT.)

(10) IF ROUND

#4 REBAR @

SECTION A-A' **ROUND FOOTING**

12" O.C. (HORIZ.),

EXCEPT 4" O.C. (TOP 3)

drawing no.: DA HOGAN 1450 114th Ave. SE, Suite 225 Bellevue, WA 98004





consultant GR GR


TtBP project number: 22079.00 file name: drawn by: LRB checked by: RSH date: 12-06-23 date: description: 09/08/23 SCHEMATIC DWGS 10/09/23 DESIGN DEVELOPMENT DWGS _ 11/01/23 _ 75% CONSTRUCTION DWGS 11/20/23 DSA SUBMITTAL 12/06/23 BID SET

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drawing title: FIELD AND TRACK SITE **DETAILS**



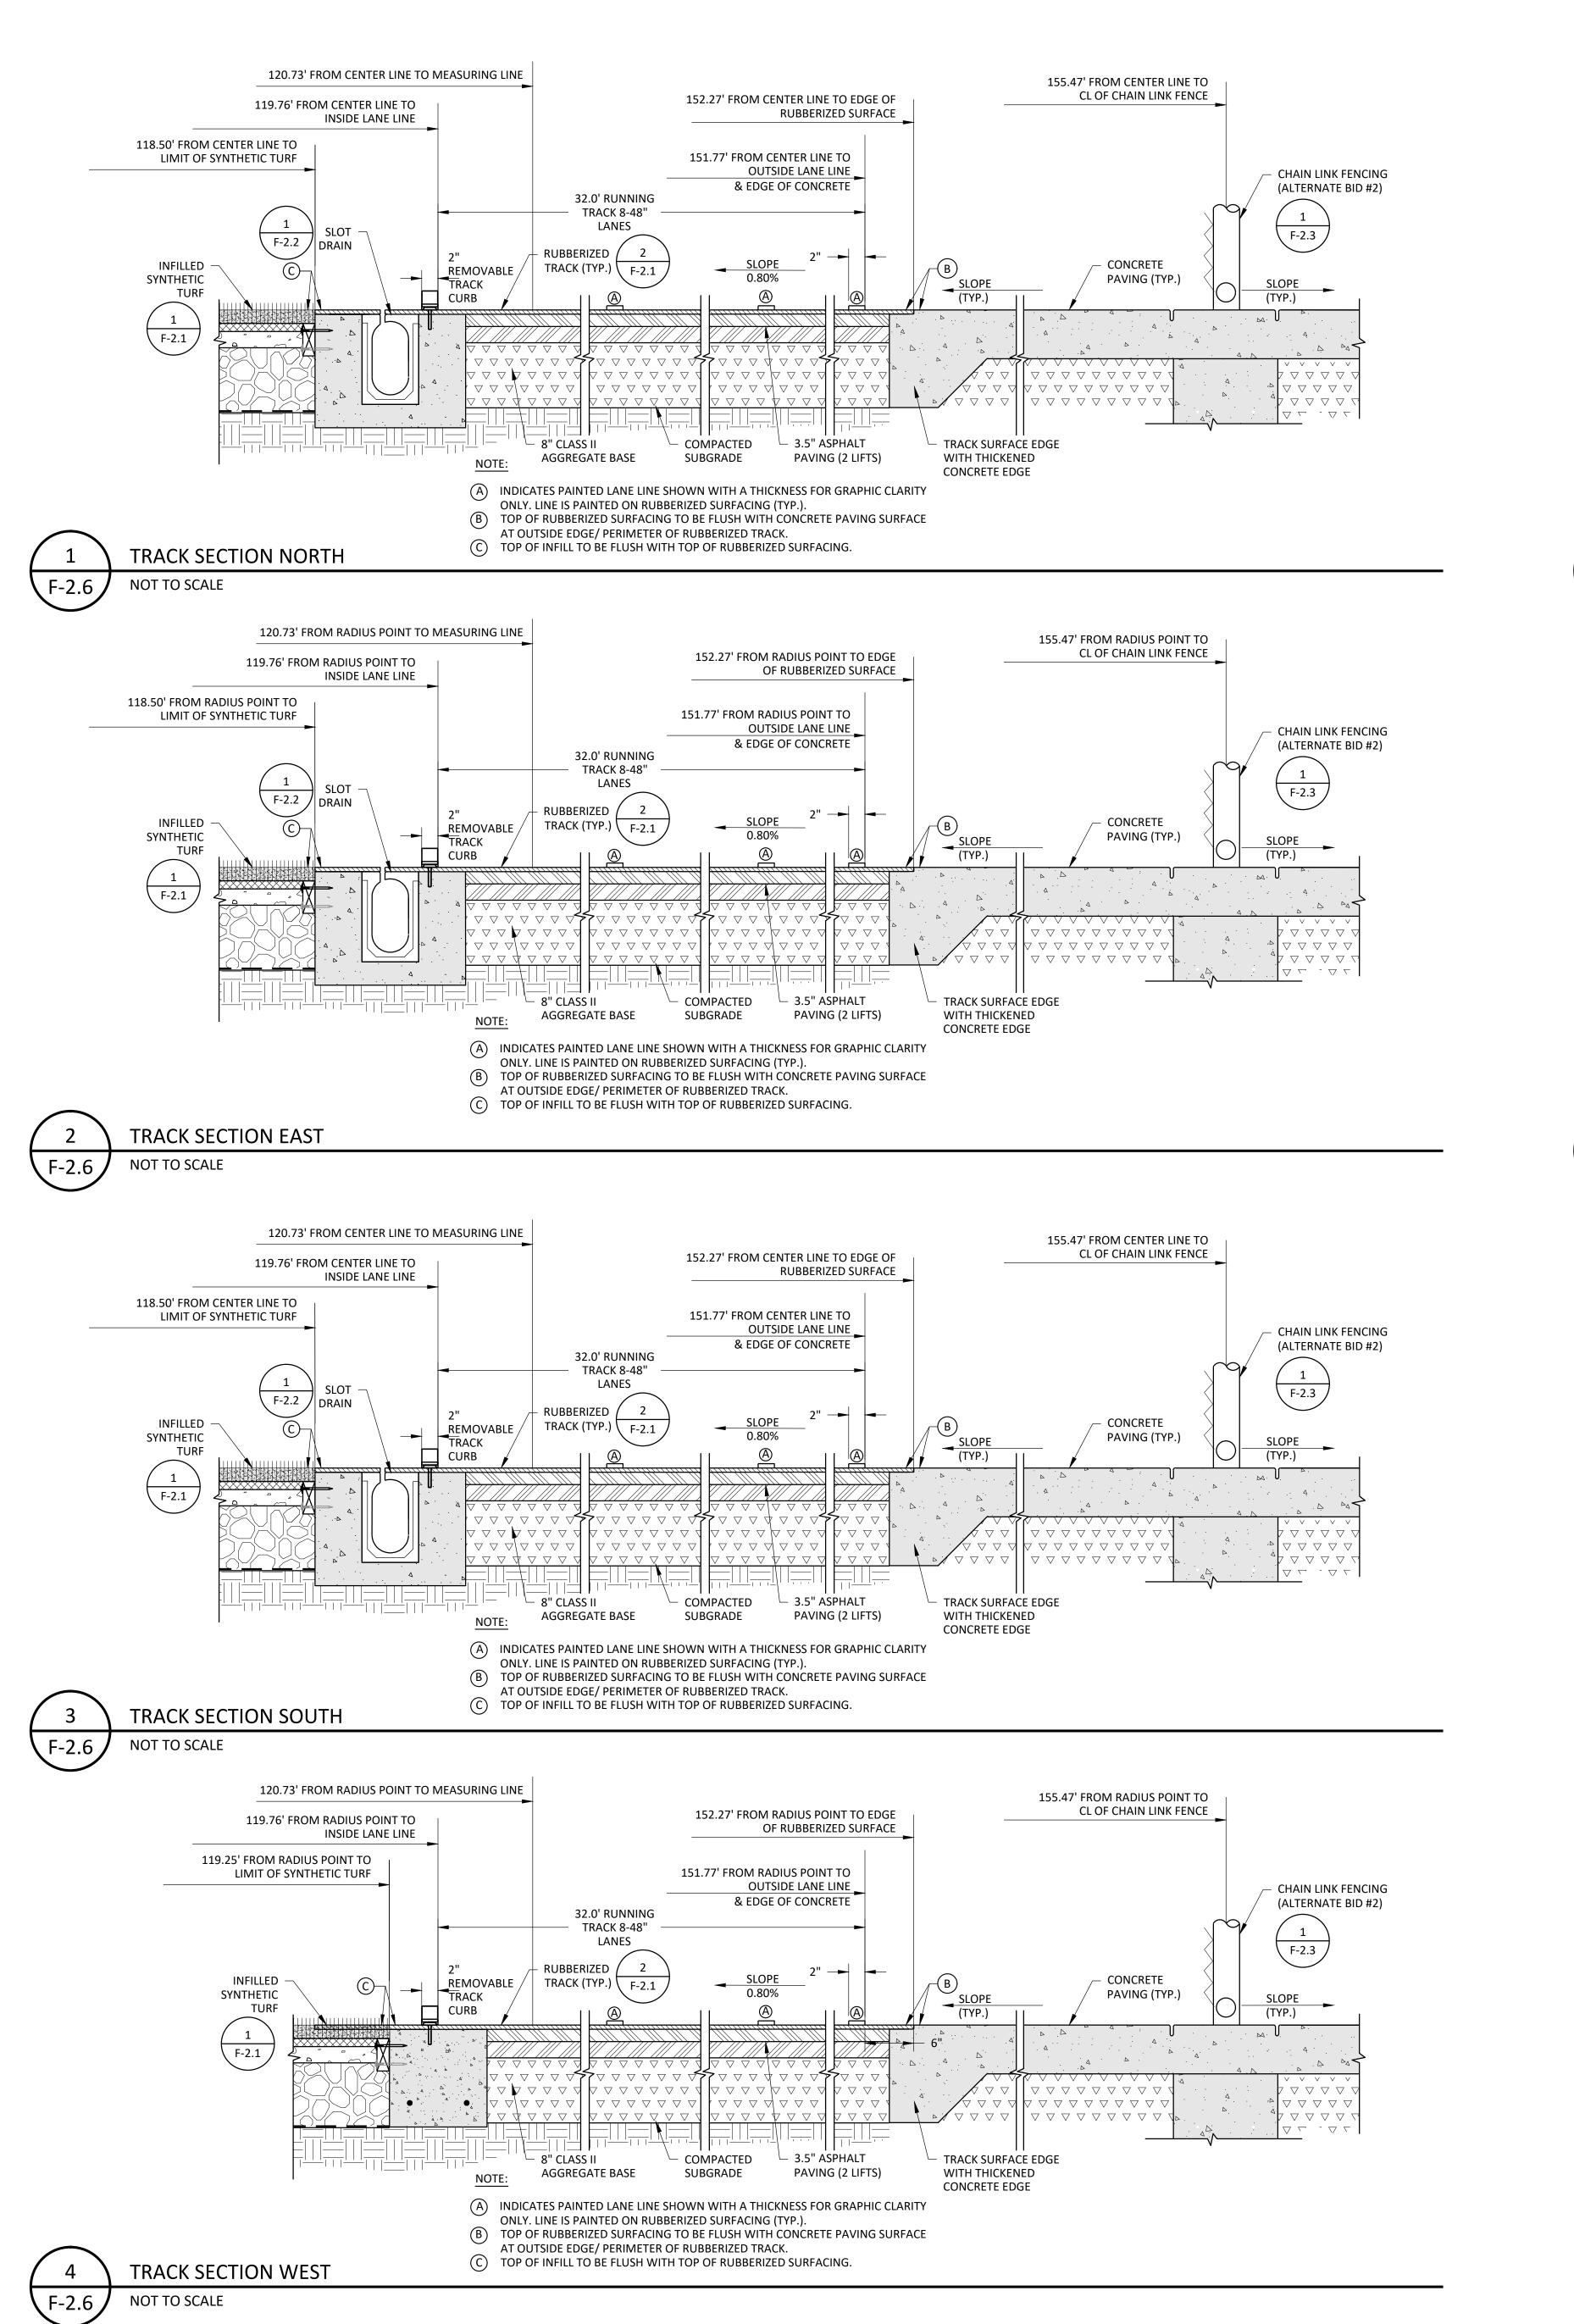

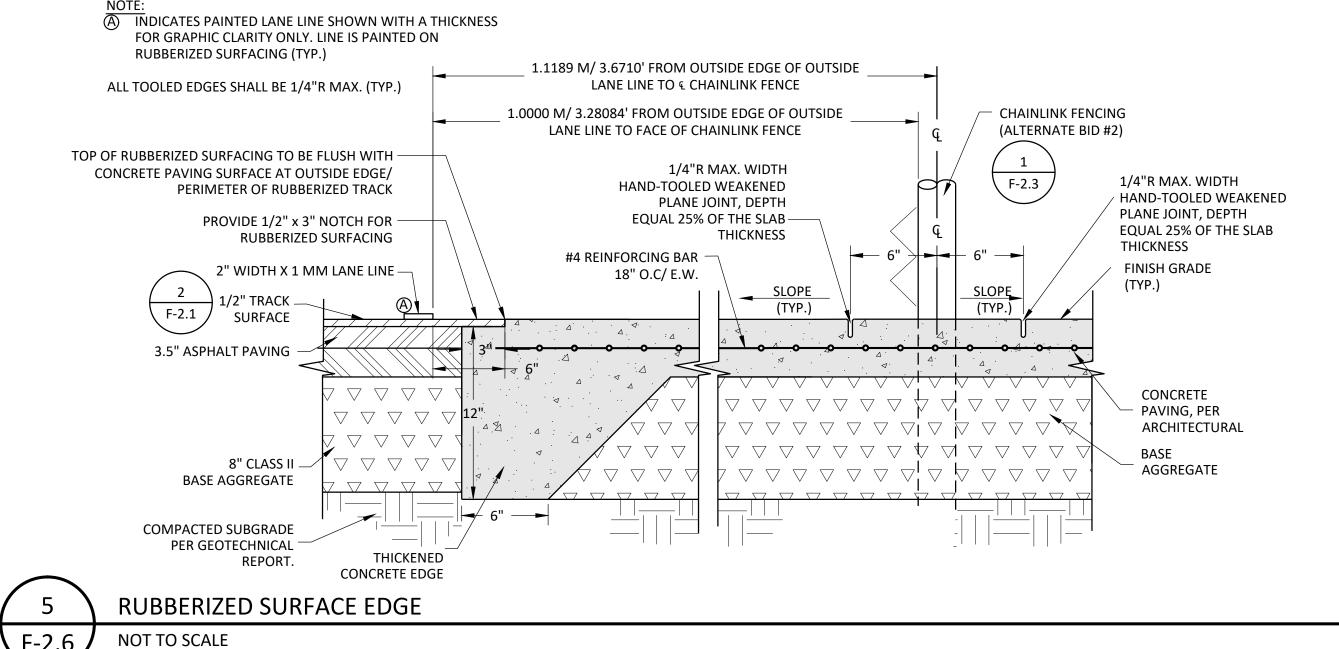

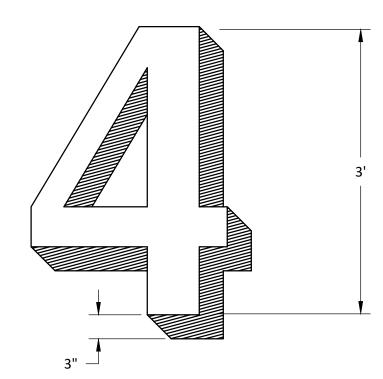
CENTER NUMBER IN LANE

F-2.6

6 TYPICAL TRACK NUMBER

NOT TO SCALE



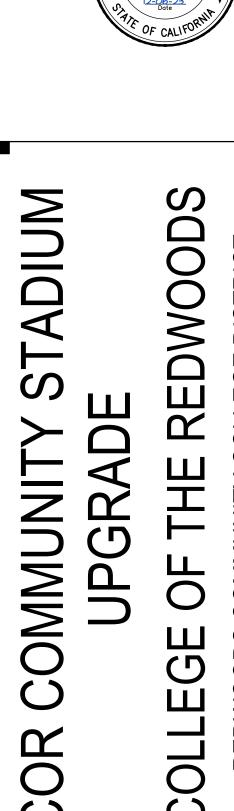

TtBP project number: 22079.00

drawn by: LRB checked by: RSH

description:

09/08/23 SCHEMATIC DWGS

10/09/23 DESIGN DEVELOPMENT DWGS

file name:

date: 12-06-23

date:

agency

architect

consultant


11/01/23 DSA SUBMITTAL

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TRACK DETAILS

drawing title:



RUNWAY AT JUMP PIT CURB

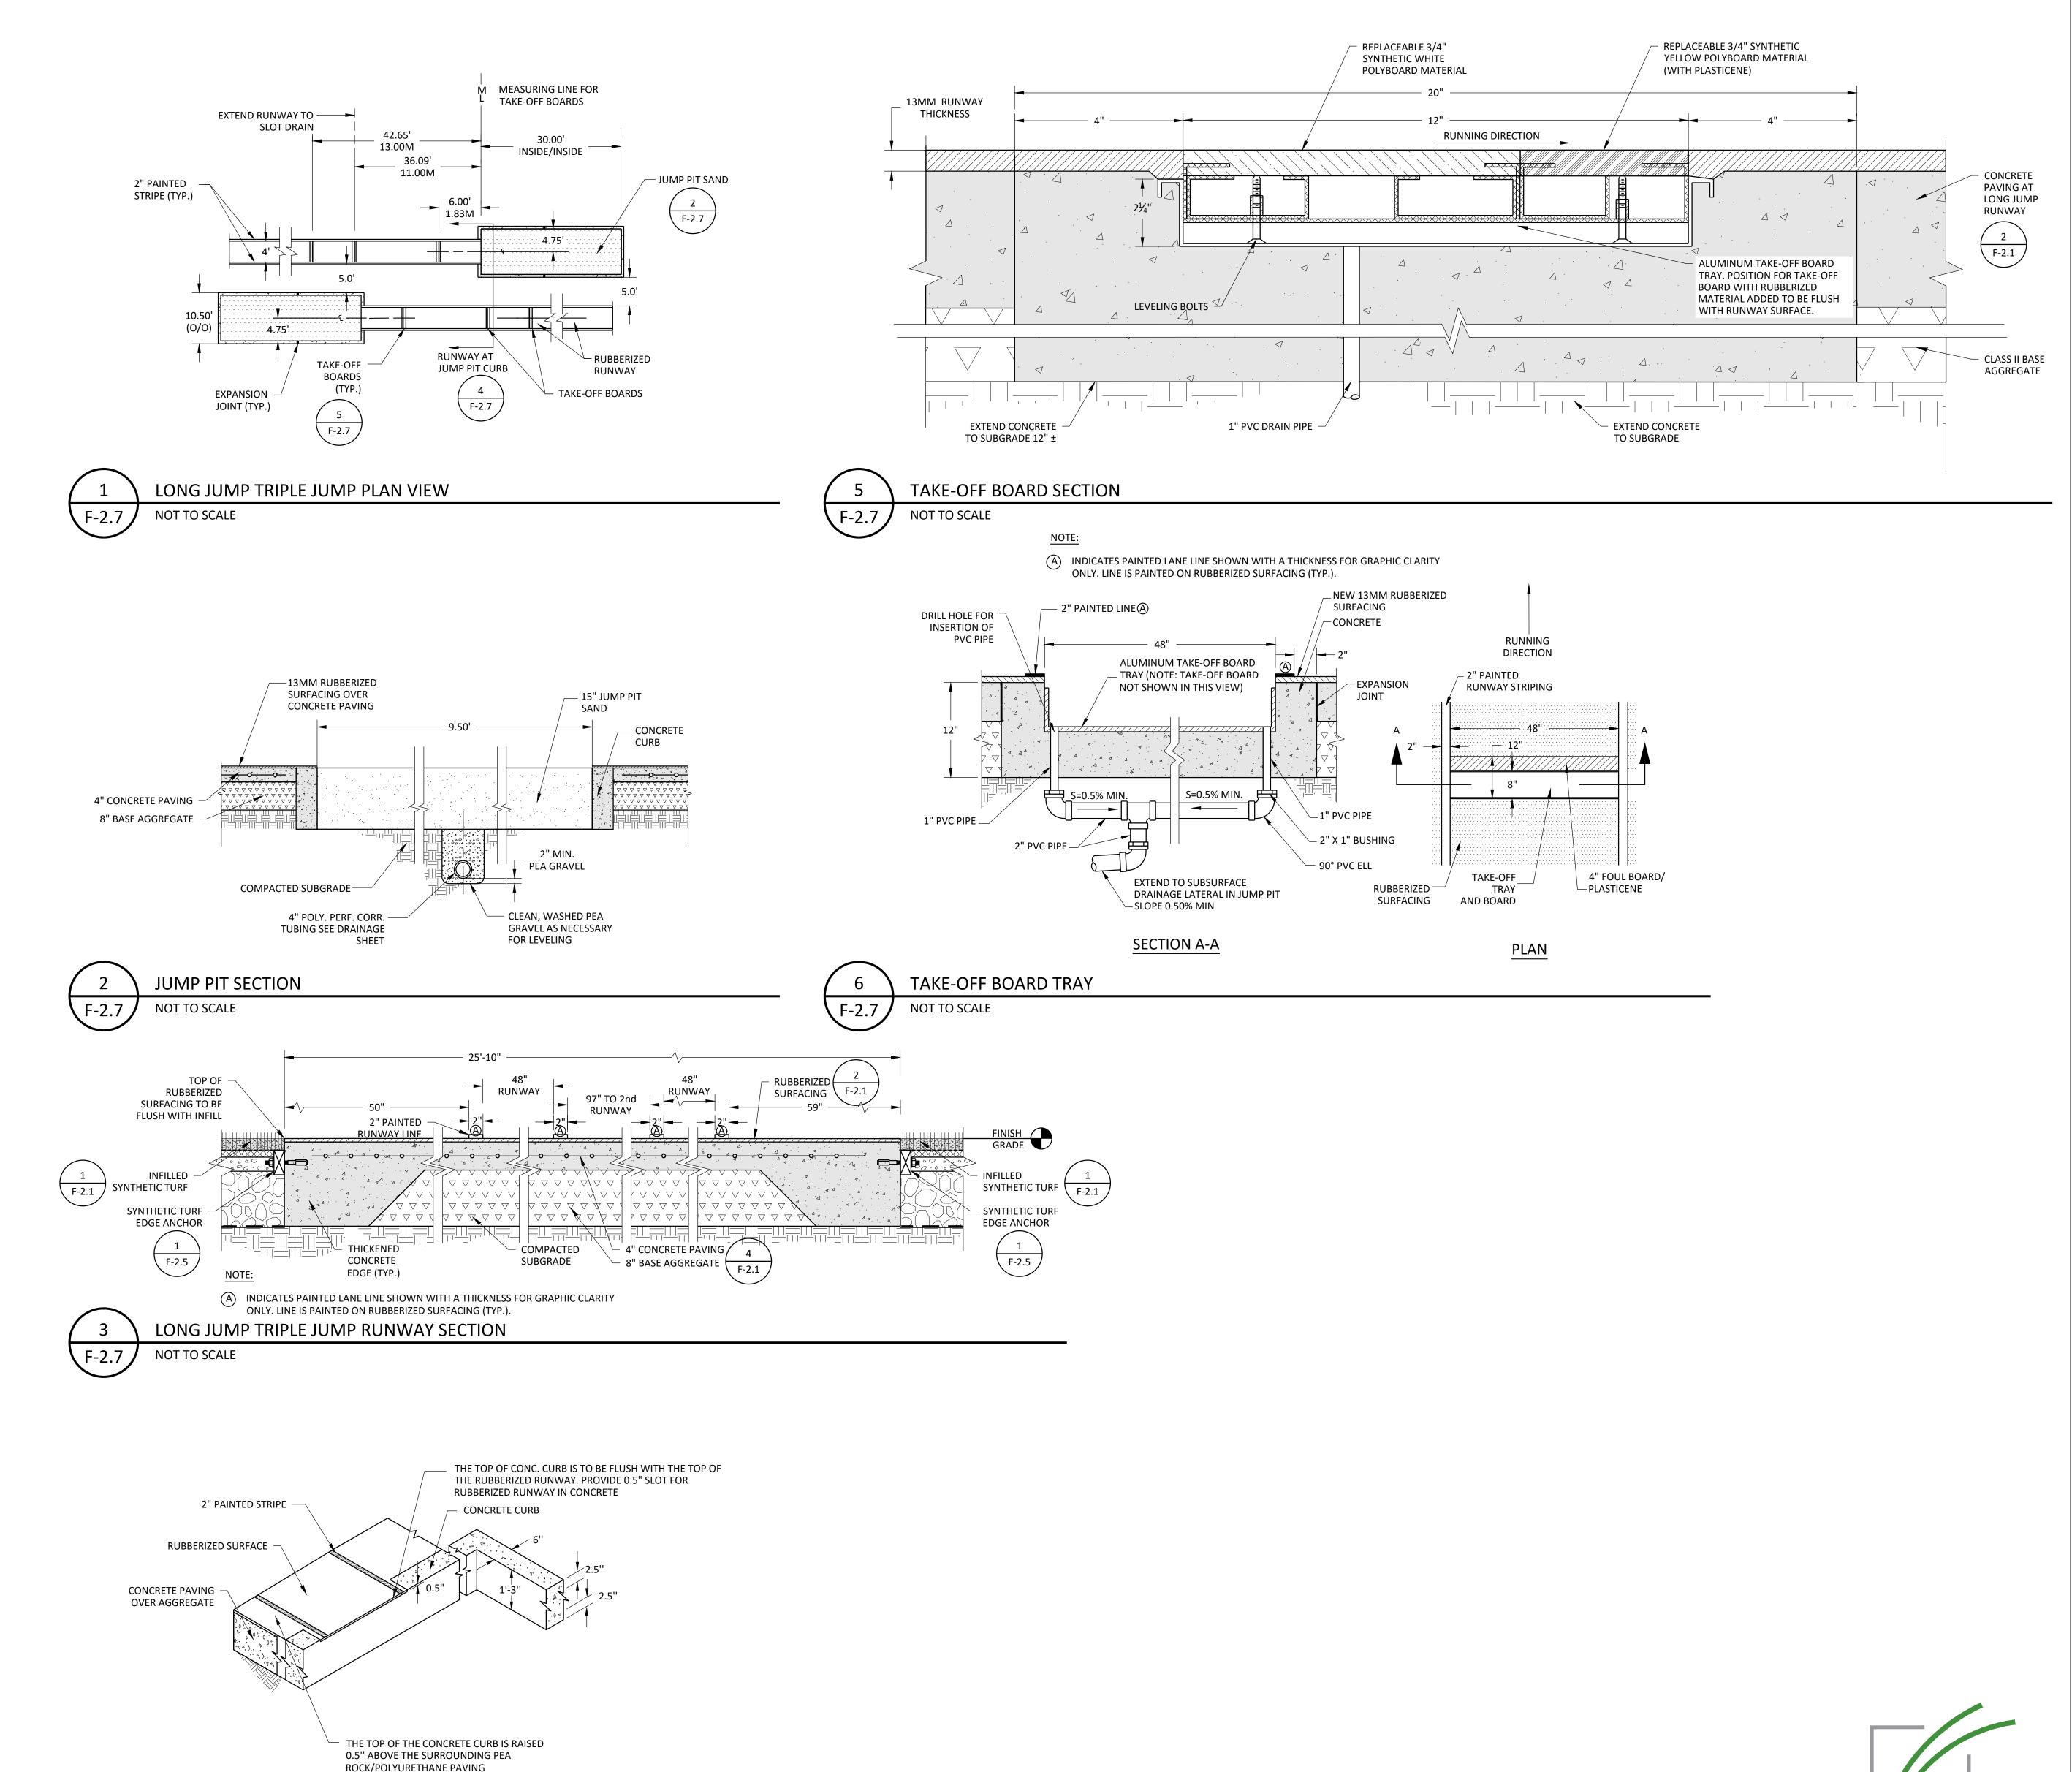NOT TO SCALE

DAHOGAN

1450 114th Ave. SE, Suite 225
Bellevue, WA 98004

p. 206.285.0400
www.dahogan.com

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TIELD EVENT DETAILS

drawing title:

drawing no.:

F-2.7

agency _

consultant

ADIUM

INNWWO

file name:

date: 12-06-23

date:

tBP project number: 22079.00

drawn by: LRB checked by: RSH

description:


_ 09/08/23 _ SCHEMATIC DWGS


10/09/23 DESIGN DEVELOPMENT DWGS

11/01/23 75% CONSTRUCTION DWGS

11/20/23 DSA SUBMITTAL

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ADIUM ST COMMUNI

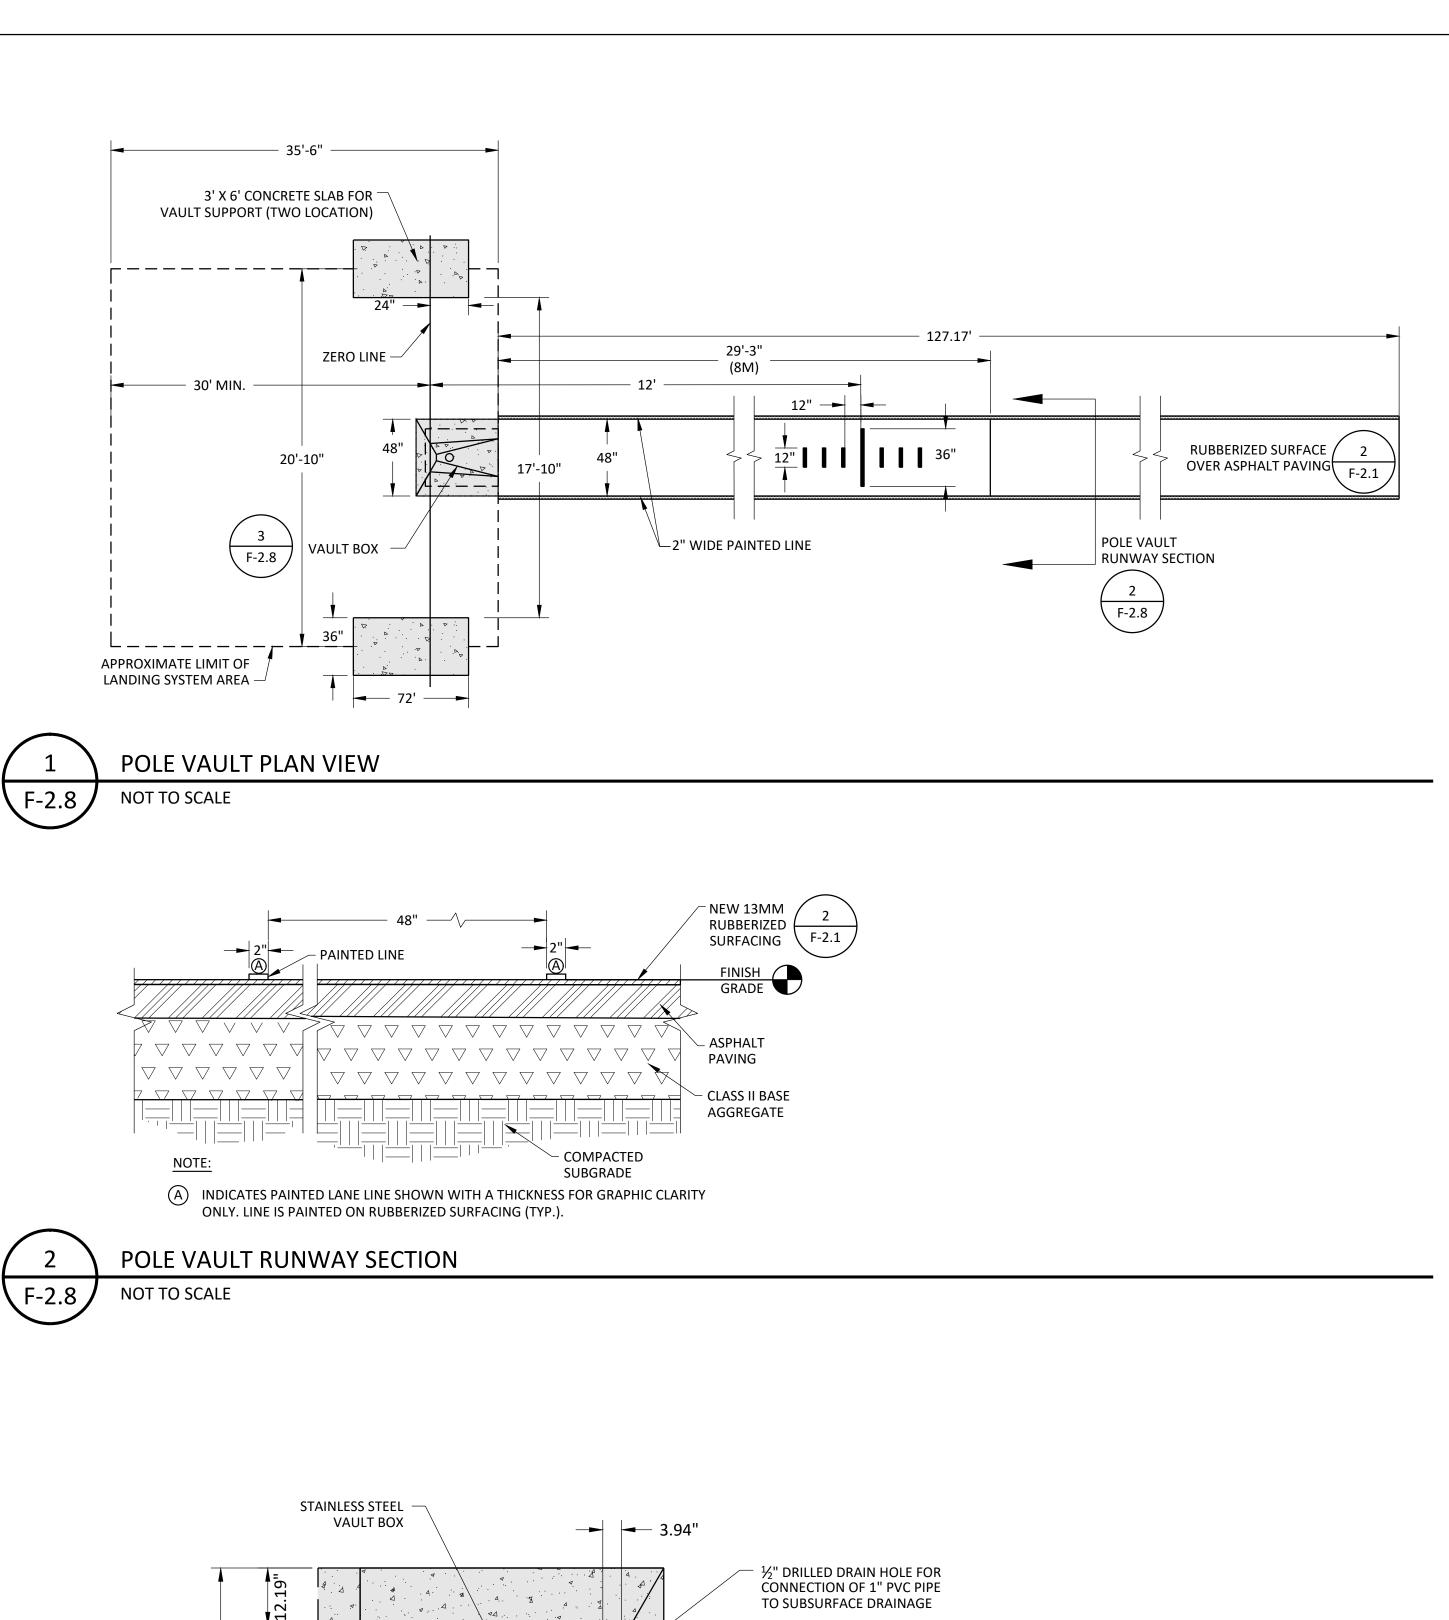
REDWOODS

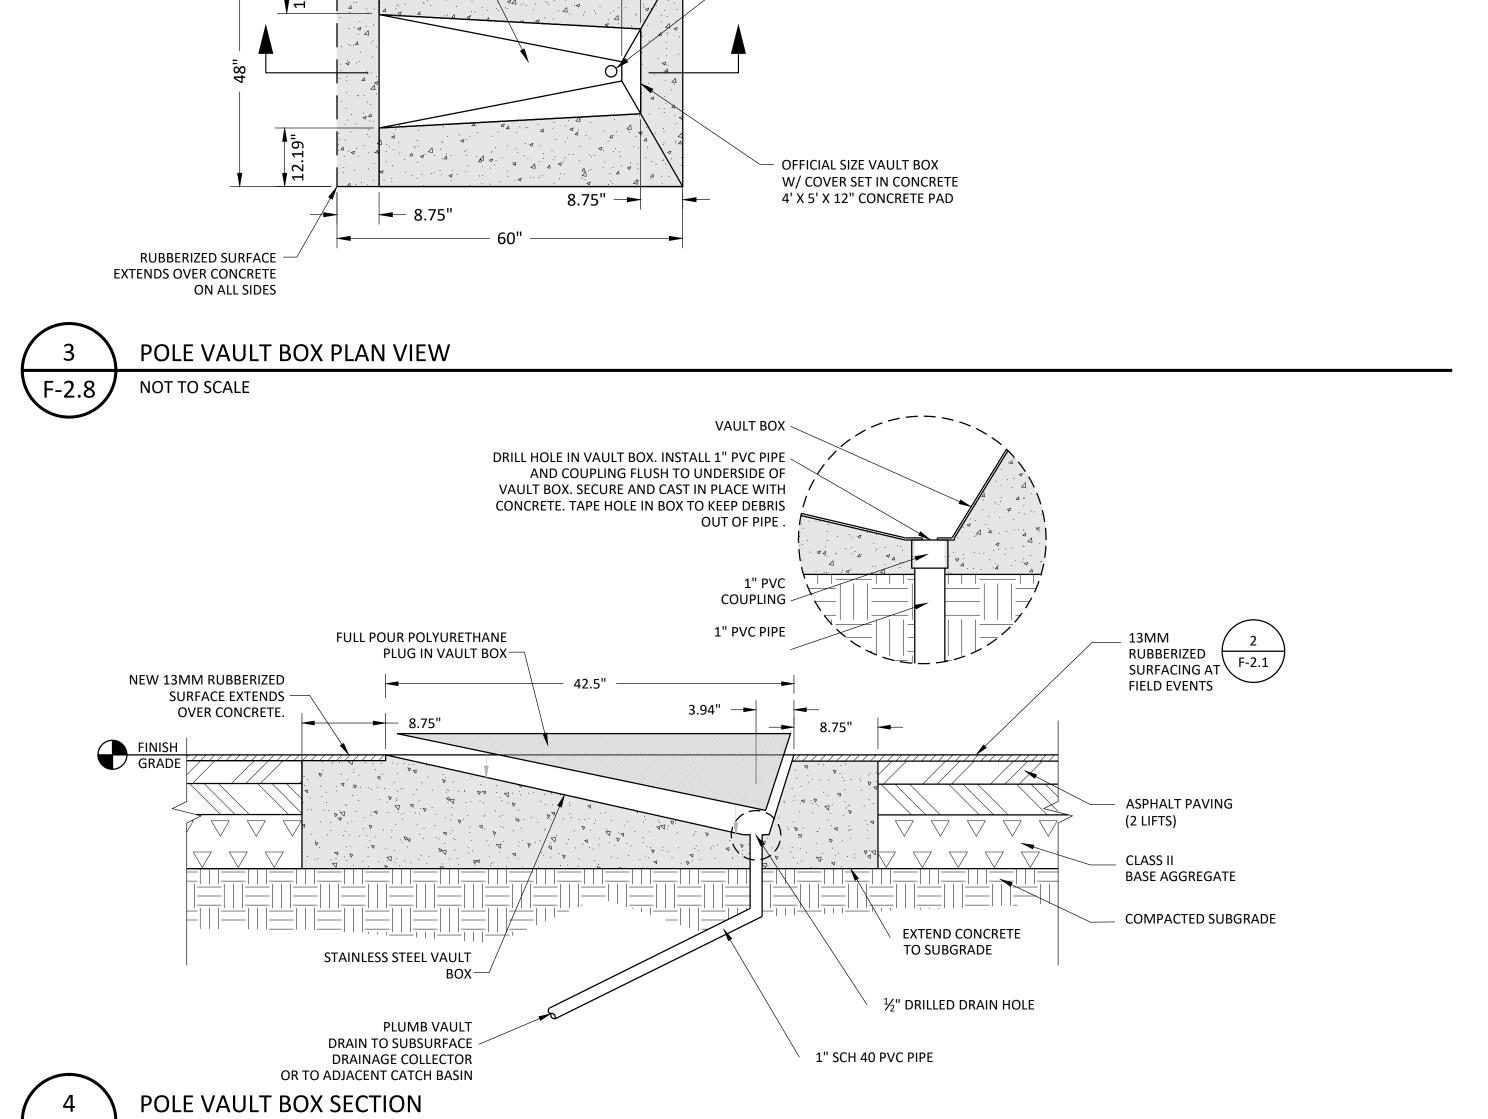agency


consultant

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drawing no.:

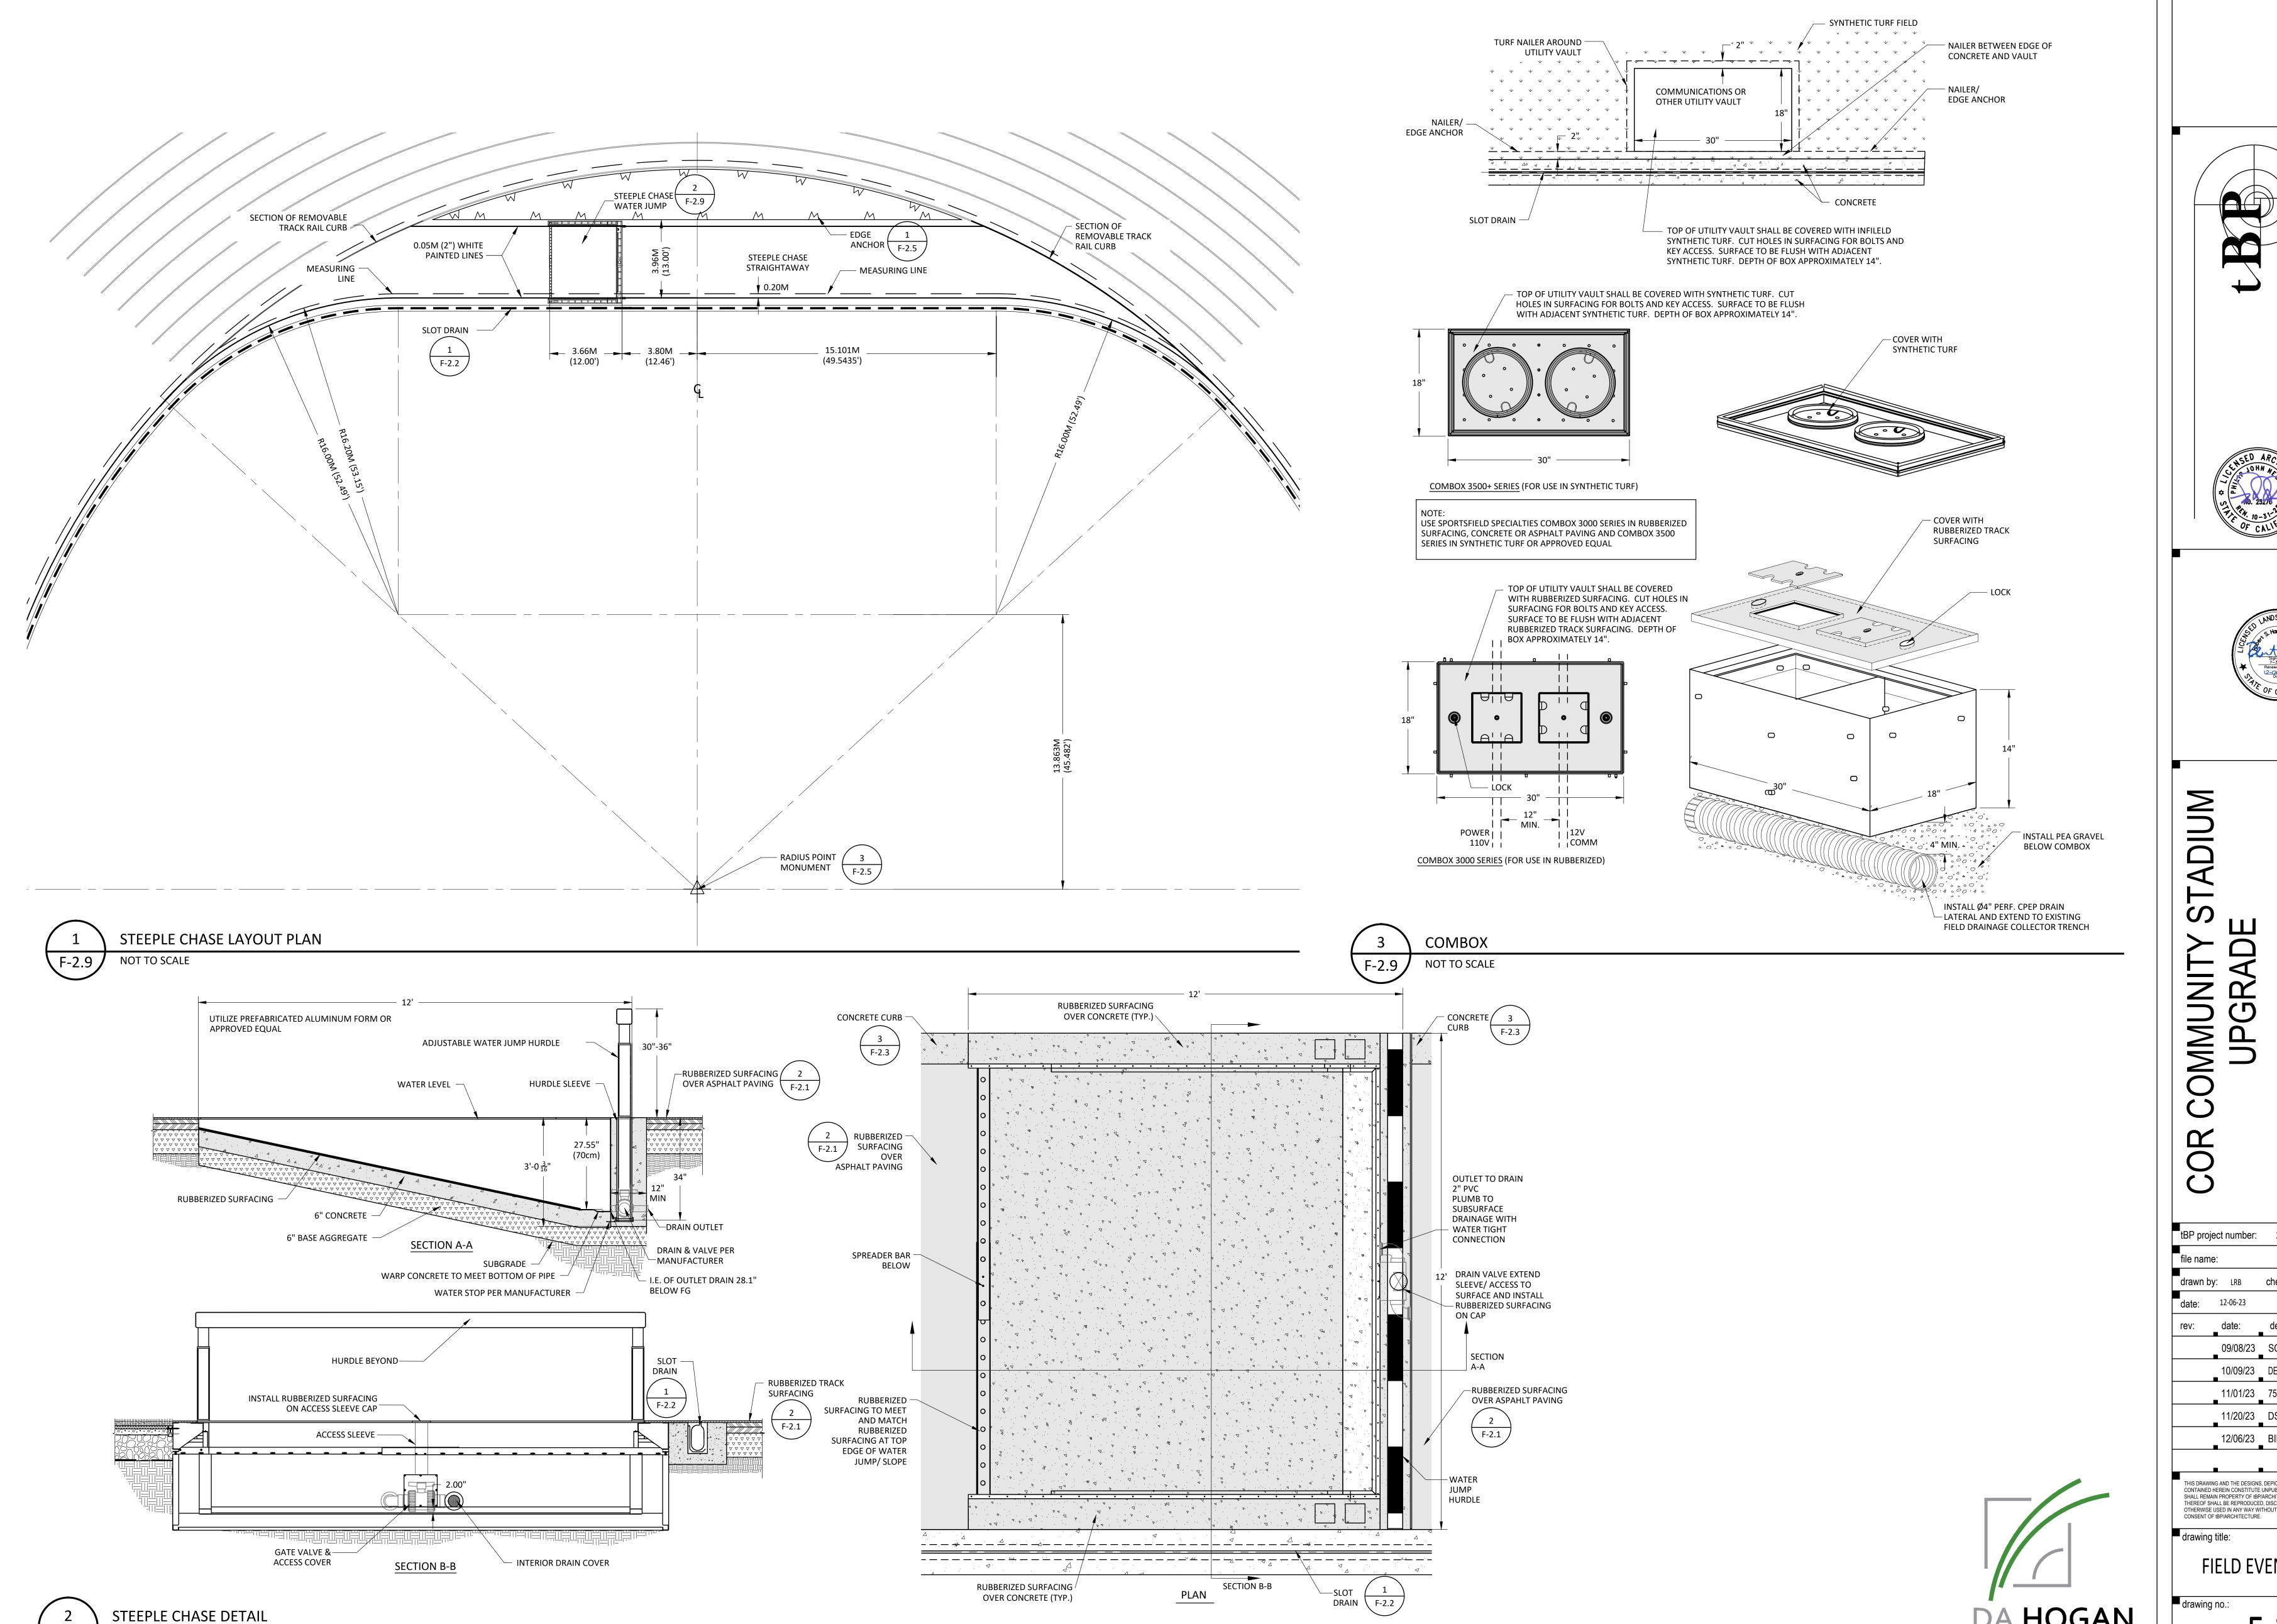

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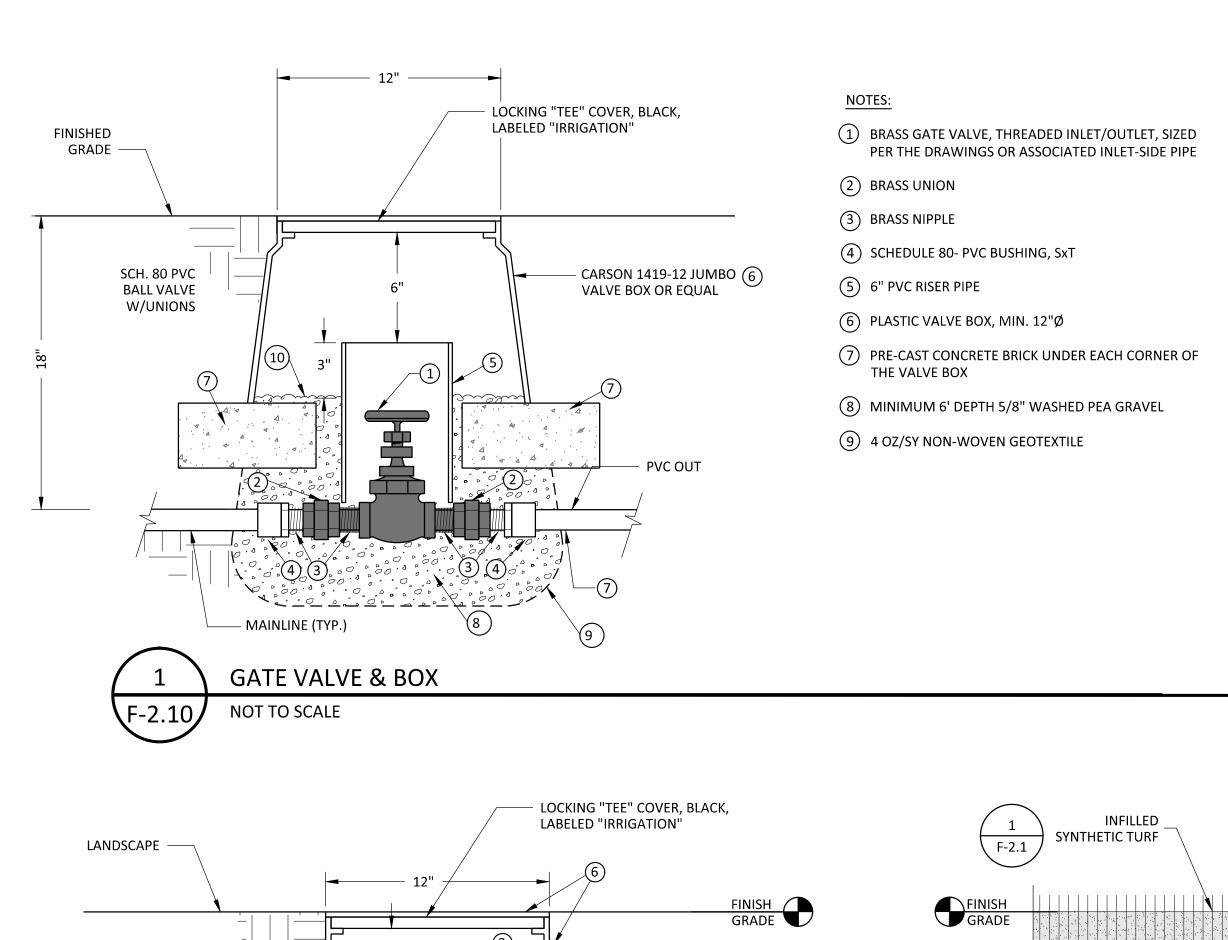



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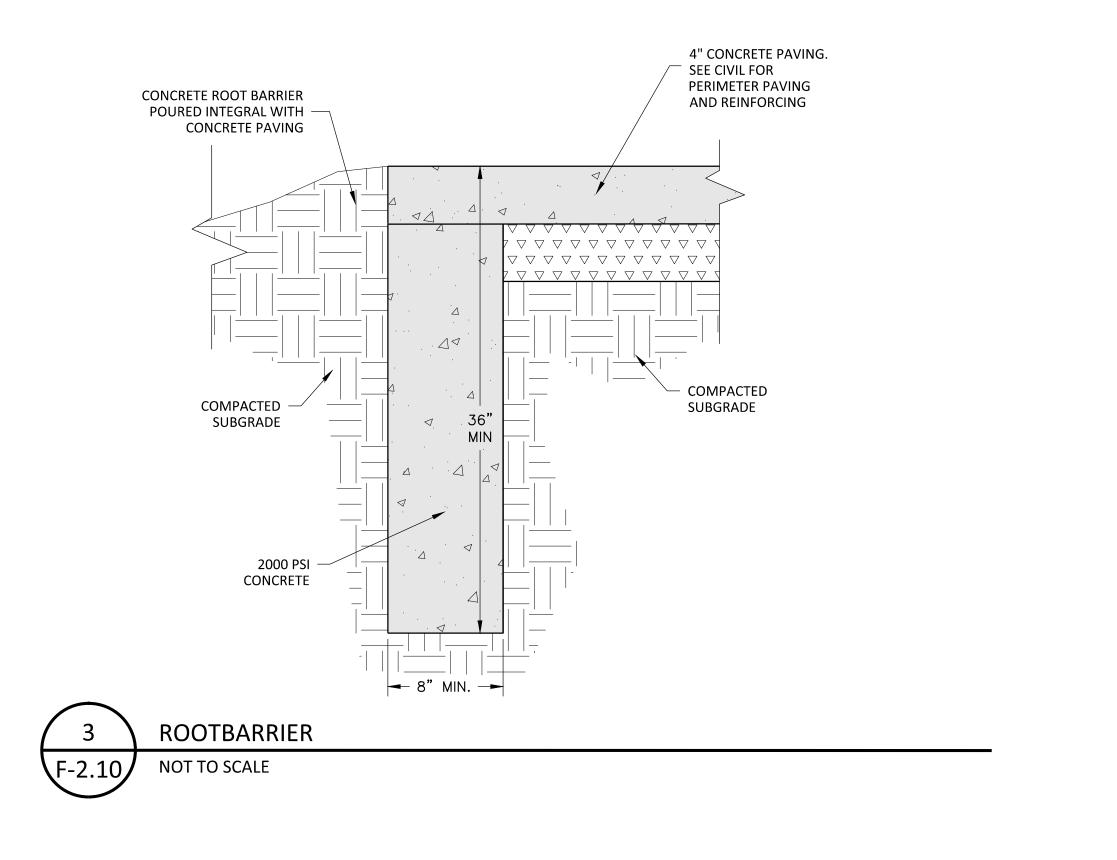
FIELD EVENT DETAILS

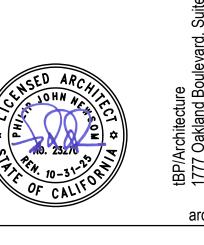Bellevue, WA 98004






QUICK COUPLING VALVE ASSEMBLY NOT TO SCALE

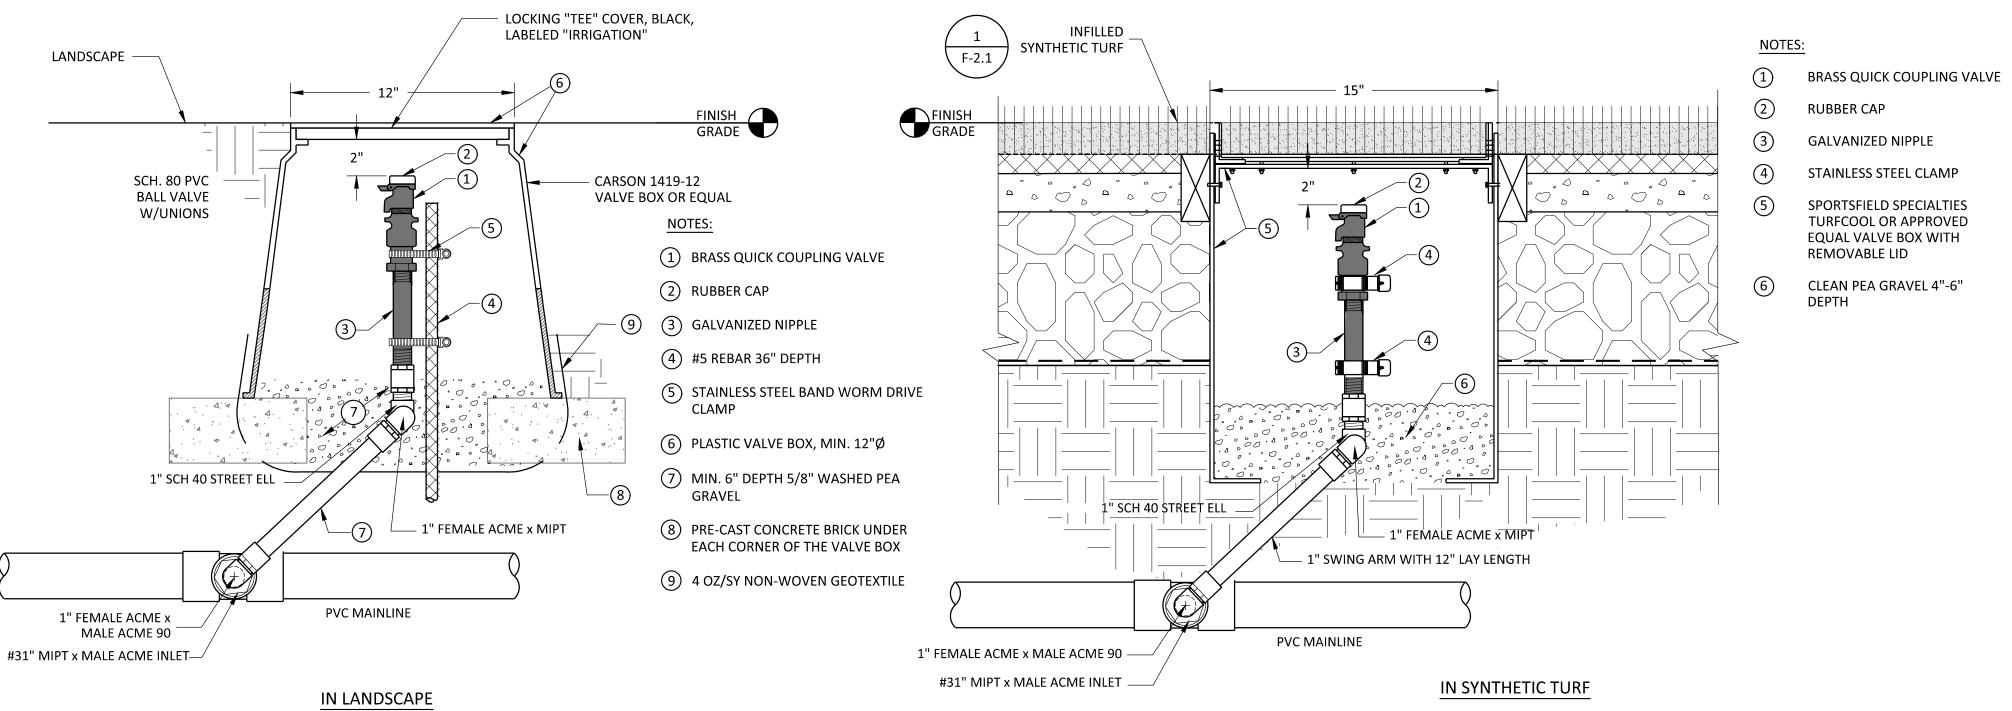




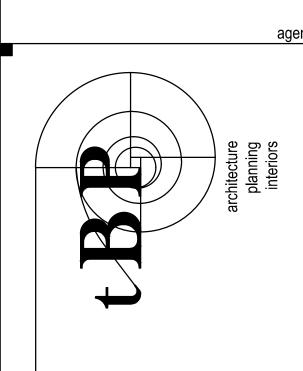





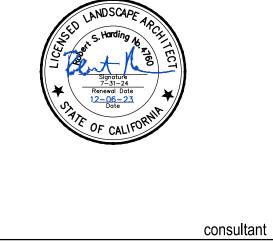

GR

COMMUNI


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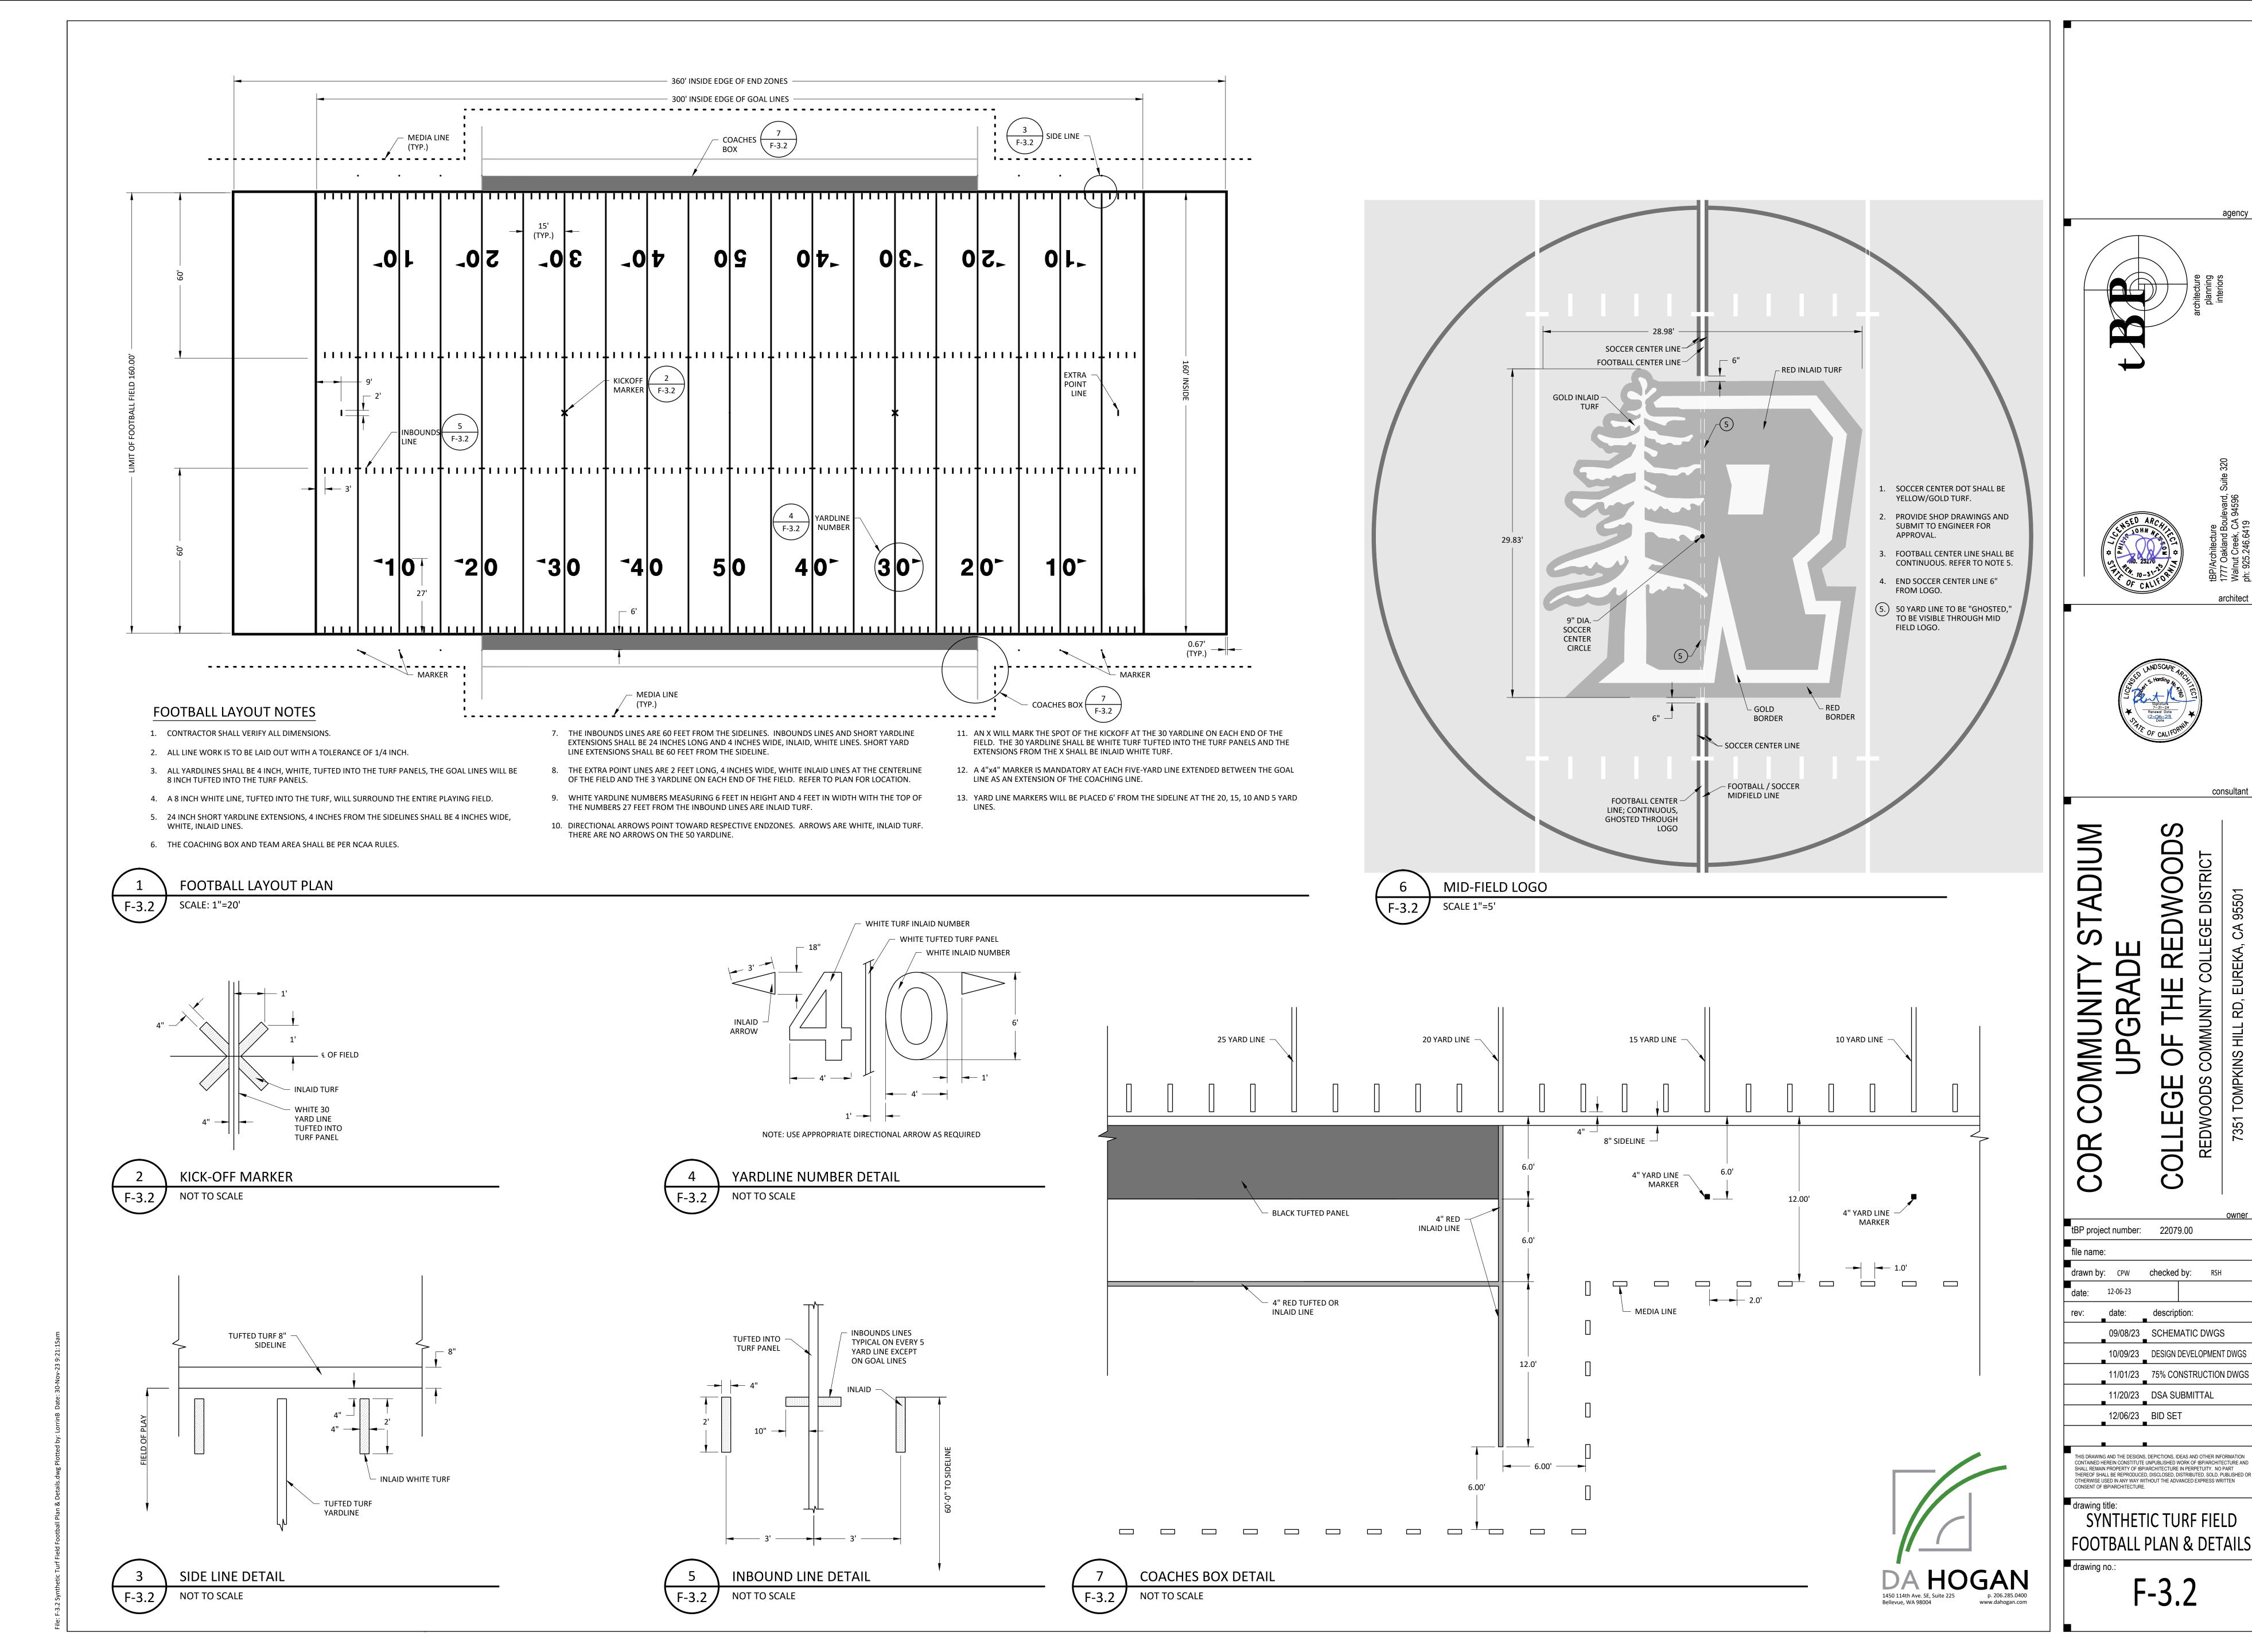
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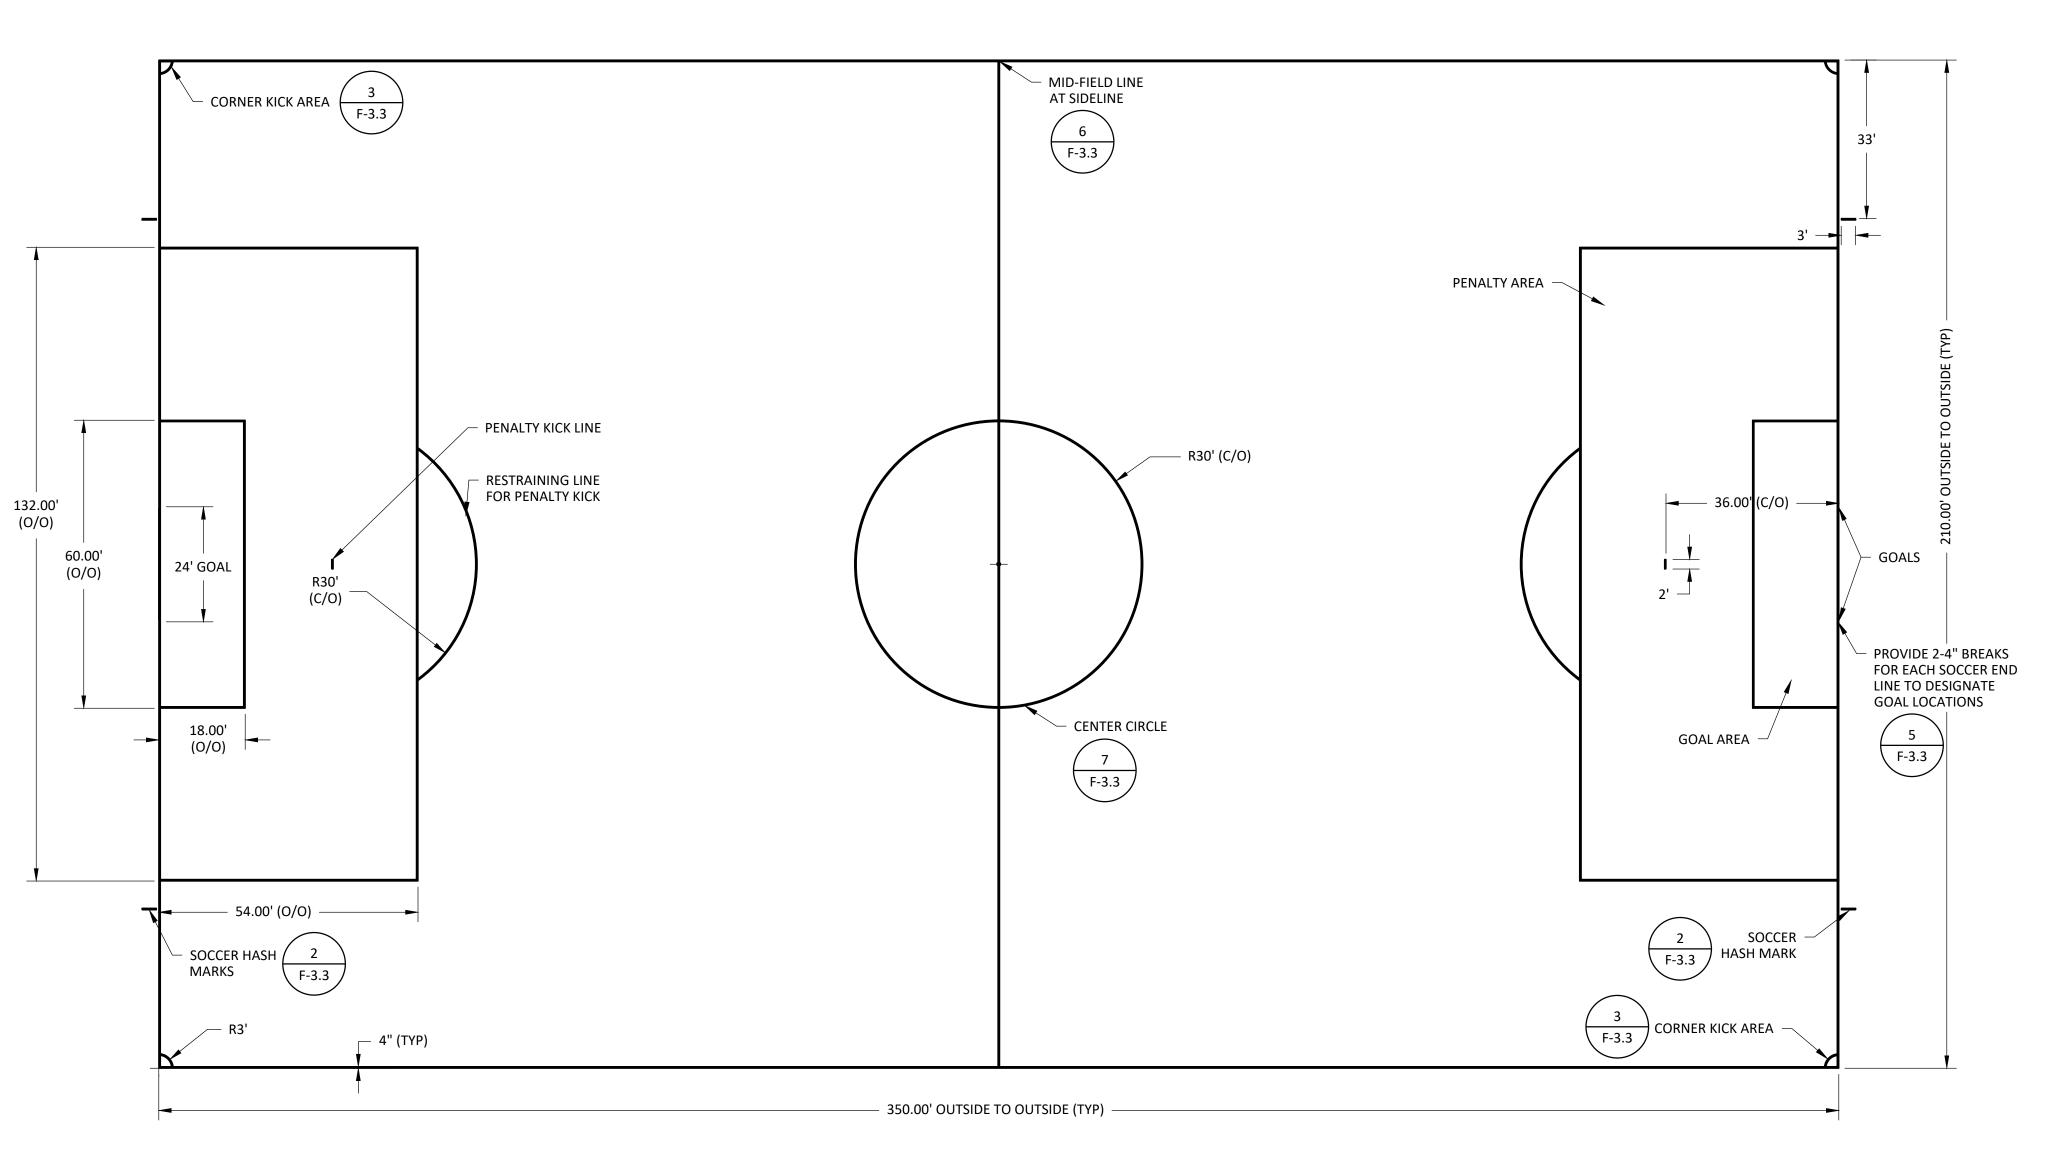
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IRRIGATION & WASHWATER DETAILS






consultant

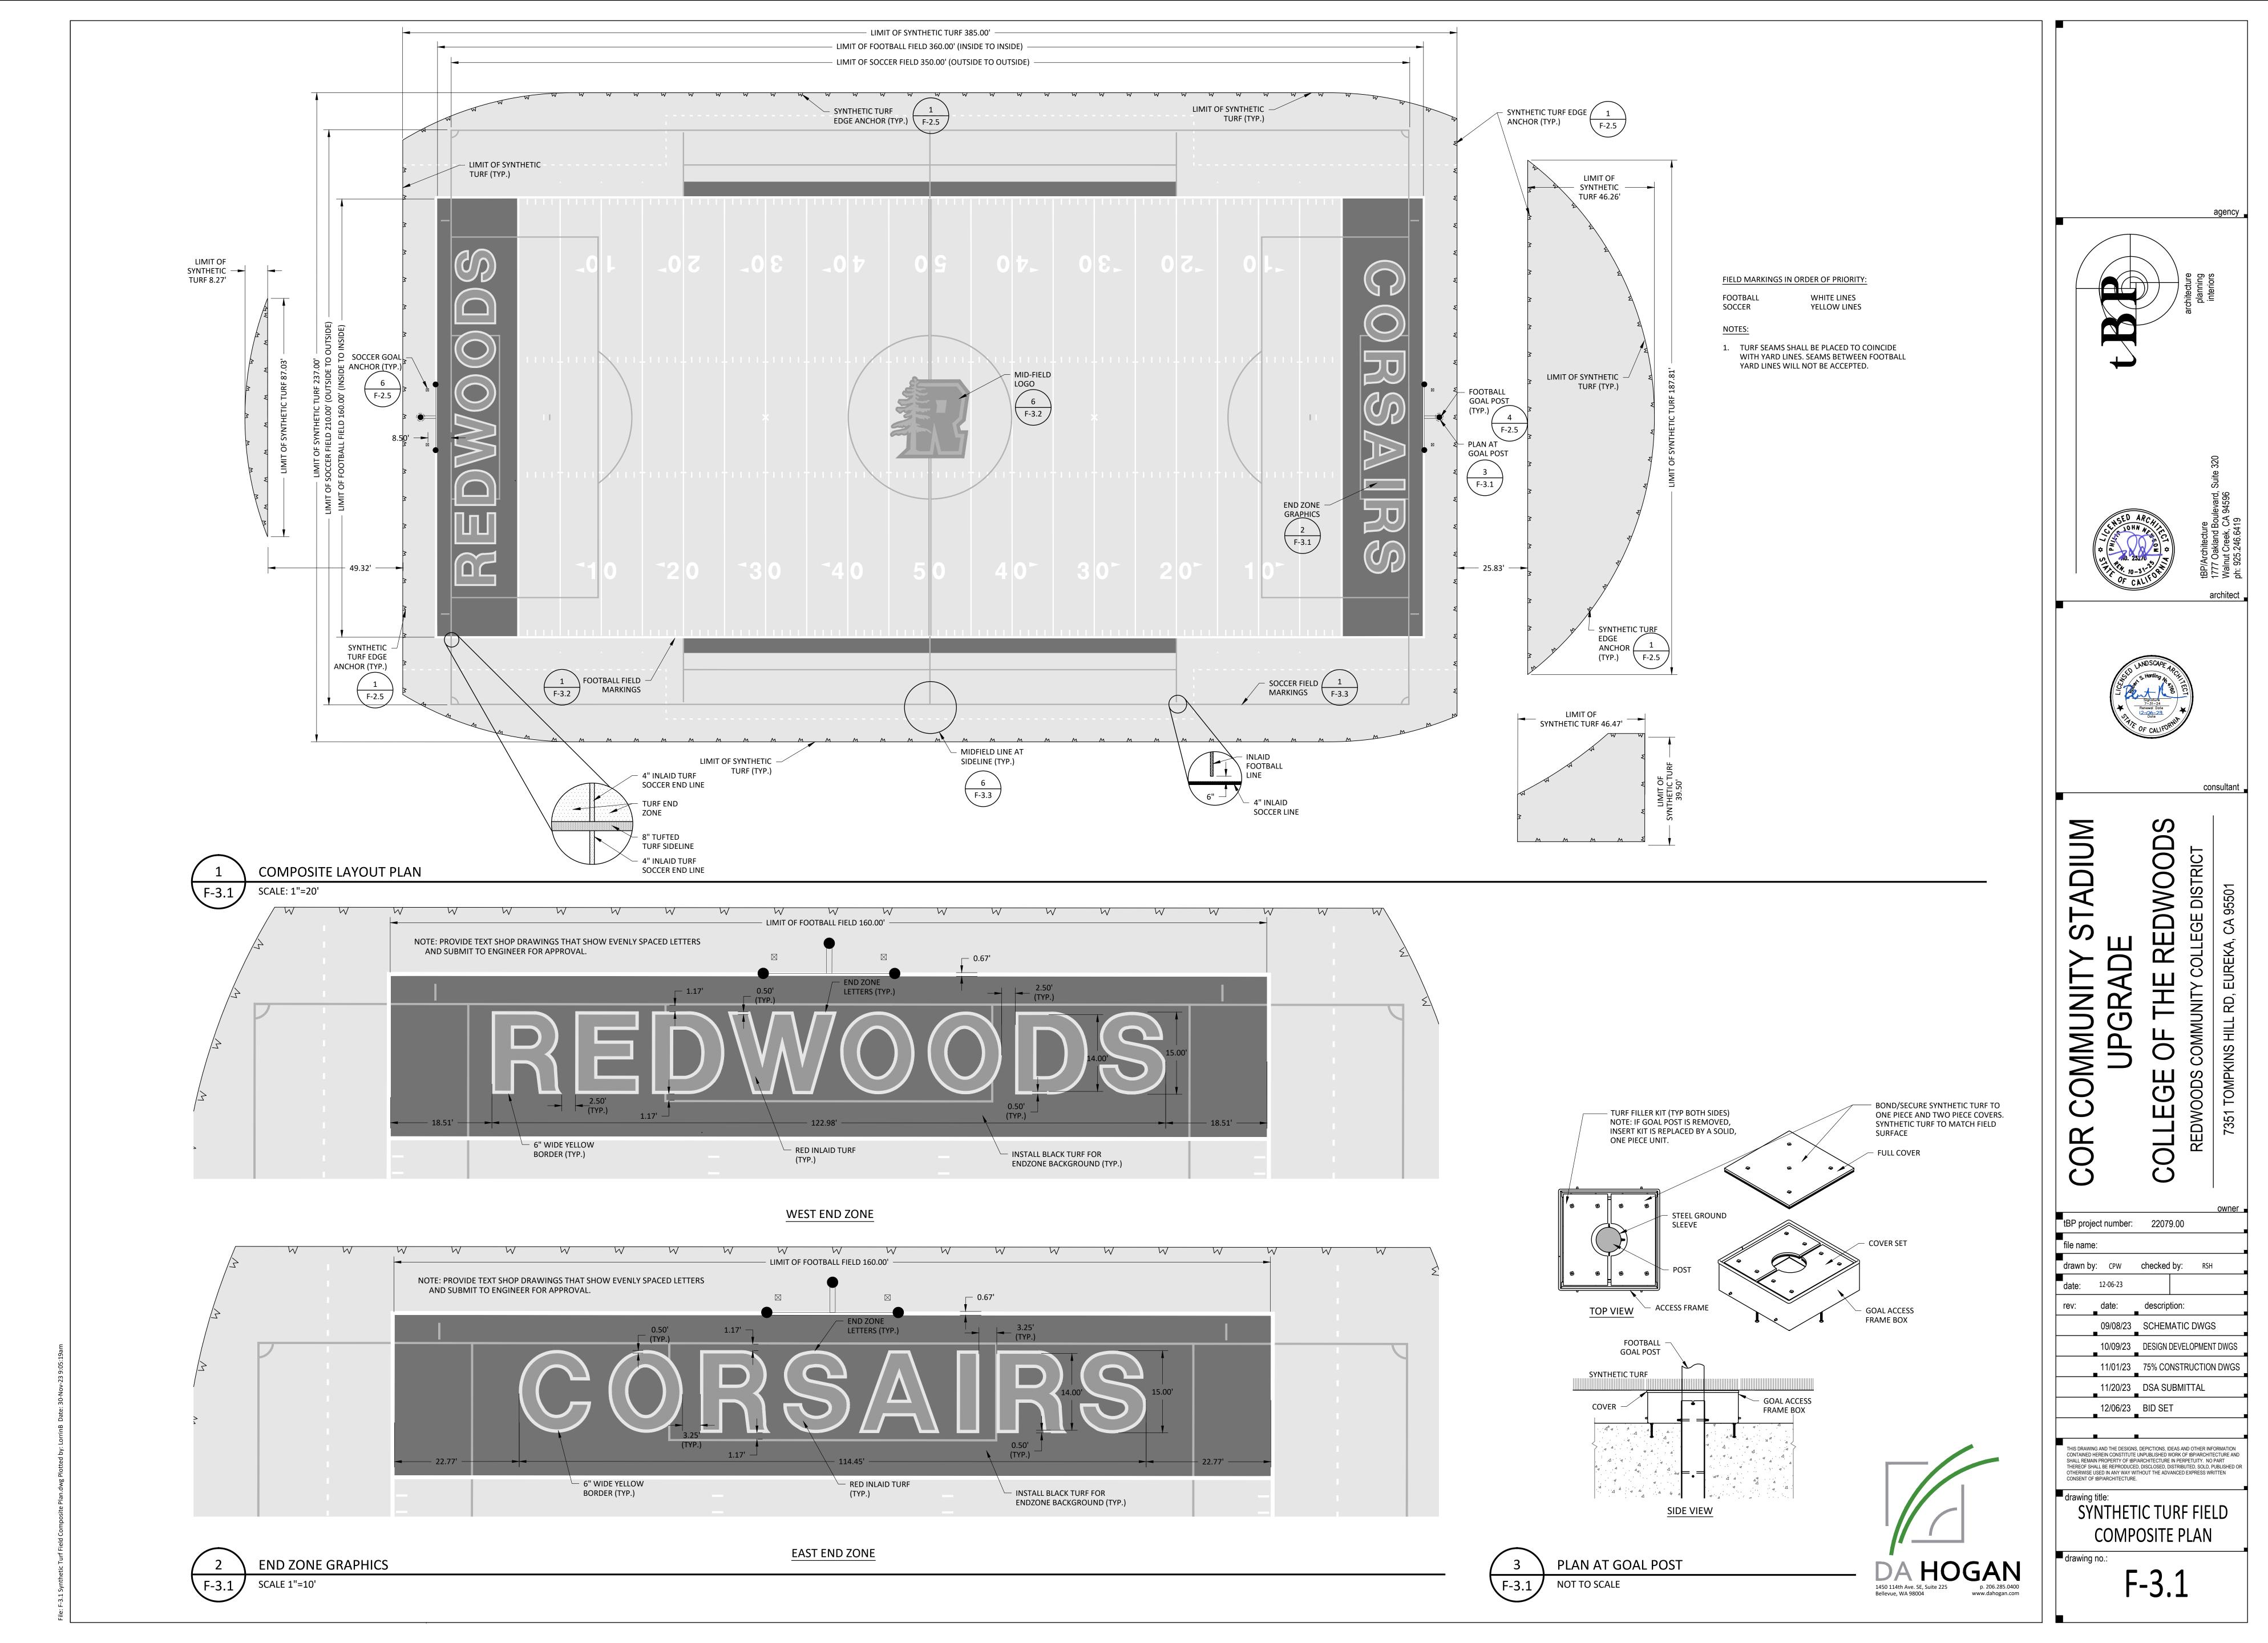


SOCCER LAYOUT NOTES

- 1. CONTRACTOR SHALL VERIFY ALL DIMENSIONS. ALL LINE WORK IS TO BE LAID OUT WITH A TOLERANCE OF 1/4 INCH.
- 2. ALL SOCCER LINES ARE 4 INCH YELLOW/GOLD INLAID TURF AS DIMENSIONED ON SOCCER LAYOUT PLAN.
- 3. THE SOCCER GOAL AREA IS 18 FEET BY 60 FEET. REFER TO PLAN FOR LOCATION.
- 4. THE SOCCER PENALTY AREA IS 54 FEET BY 132 FEET.
- 5. THE PENALTY MARK IS A 2 FOOT LINE, 4 INCHES WIDE, 36 FEET FROM THE END LINE AND CENTERED ON THE GOAL. THE RESTRAINING LINE FOR PENALTY KICK AN ARC 30 FEET FROM THIS MARK OUTSIDE OF THE PENALTY AREA. REFER TO PLAN FOR LOCATION.
- THE HALFWAY LINE FOR THE SOCCER FIELD IS A 4 INCH YELLOW INLAID LINE WITH A CIRCLE, 30 FEET IN RADIUS IN THE CENTER OF THE FIELD. THE RADIUS POINT OF THE MIDFIELD CIRCLE WILL BE INLAID YELLOW DOT WITH A 9 INCH DIAMETER. THE FOOTBALL LINES WILL PASS THROUGH THE SOCCER LINES. THE 50 YARD LINE OF THE FOOTBALL FIELD WILL BE WHITE WITH 4 INCHES OF YELLOW INLAID TURF ON EACH SIDE AND WILL EXTEND TO THE SIDELINE OF THE FOOTBALL FIELD.
- 7. THE SOCCER LINE WILL EXTEND BEYOND THE FOOTBALL SIDELINE BEGINNING 4 INCHES OUTSIDE THE 8 INCH SIDELINE AND EXTENDING THROUGH THE COACHES BOX.
- 8. THE CORNERS OF THE SOCCER FIELD SHALL HAVE A 3 FOOT RADIUS IN YELLOW TURF DESIGNATING THE CORNER KICK AREA.THE HASH MARK IS A 3 FOOT LINE, 4 INCHES WIDE, 33 FEET FROM THE SIDE LINE AND EXTENDS AWAY FROM THE FIELD OF PLAY.


SOCCER LAYOUT PLAN

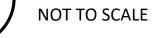


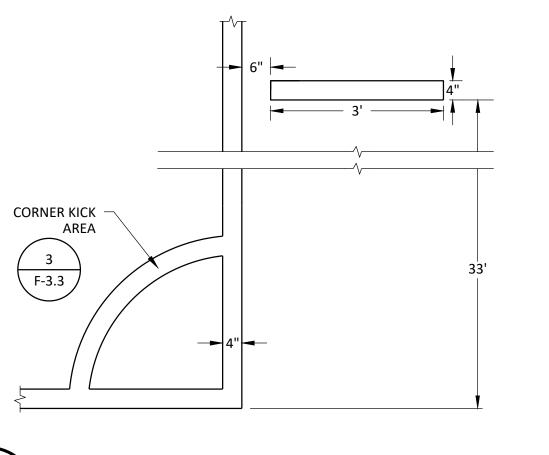



SOCCER HASH MARKS

NOT TO SCALE

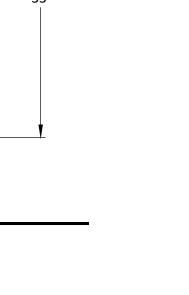

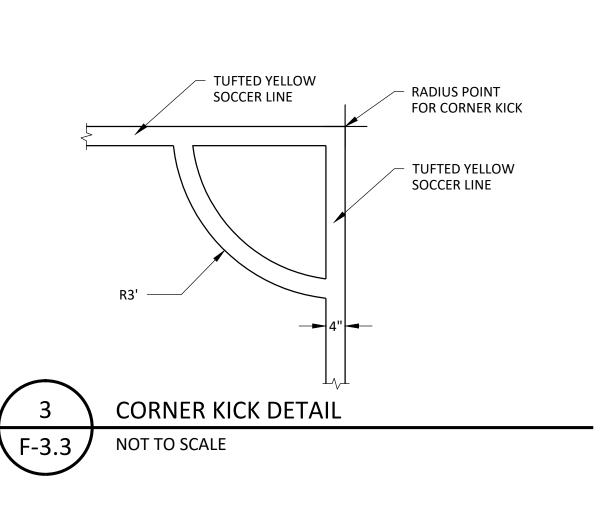


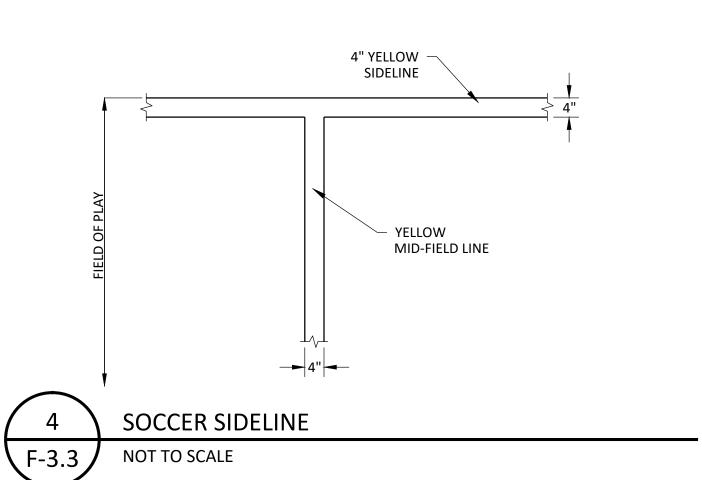

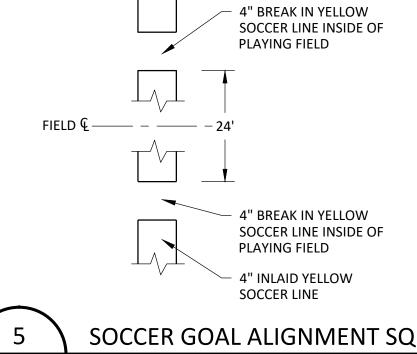



SOCCER GOAL ALIGNMENT SQUARES

NOT TO SCALE

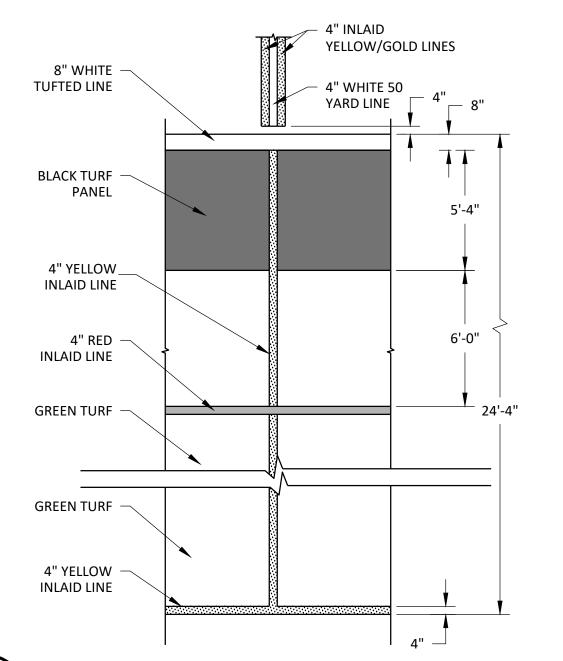

MID-FIELD LINE AT SIDELINE NOT TO SCALE

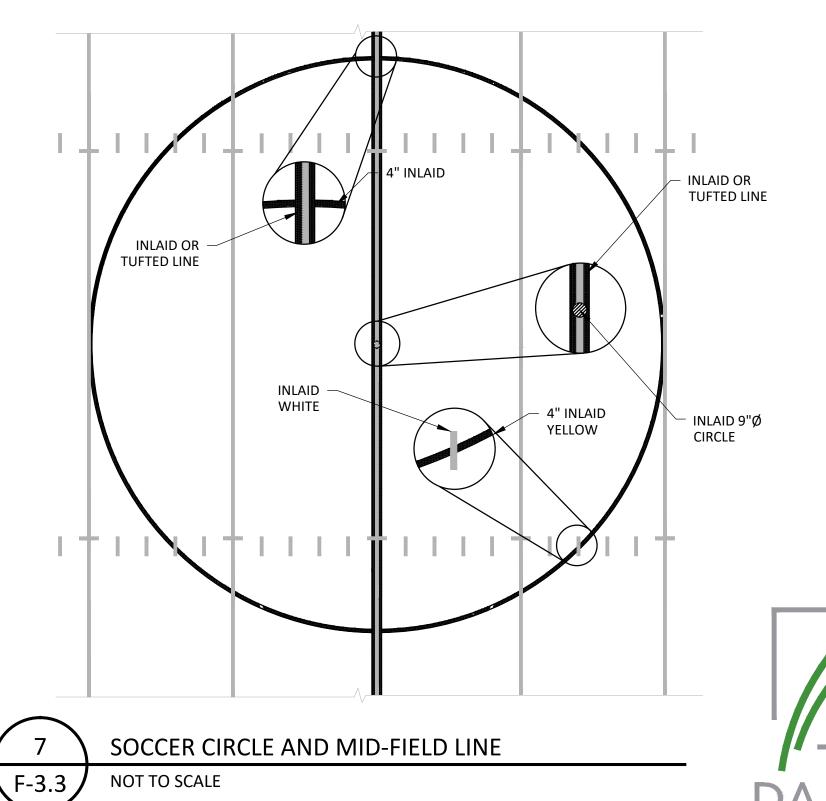

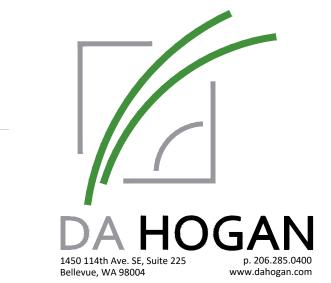

consultant

tBP project number: 22079.00 file name: drawn by: CPW checked by: RSH date: 12-06-23 date: description: 09/08/23 SCHEMATIC DWGS 10/09/23 DESIGN DEVELOPMENT DWGS 11/01/23 75% CONSTRUCTION DWGS 11/20/23 DSA SUBMITTAL 12/06/23 BID SET THIS DRAWING AND THE DESIGNS, DEPICTIONS, IDEAS AND OTHER INFORMATION CONTAINED HEREIN CONSTITUTE UNPUBLISHED WORK OF 18P/ARCHITECTURE AND SHALL REMAIN PROPERTY OF 18P/ARCHITECTURE IN PERPETUITY. NO PART THEREOF SHALL BE REPRODUCED, DISCLOSED, DISTRIBUTED, SOLD, PUBLISHED OR OTHERWISE USED IN ANY WAY WITHOUT THE ADVANCED EXPRESS WRITTEN CONSENT OF 19P/APCHITECTURE.

drawing title:

SYNTHETIC TURF FIELD SOCCER PLAN & DETAILS

drawing no.:

F-3.3